


SLAB EDGE AT STAIR




VERTICAL WALL CONTROL AND CONSTRUCTION JOINTS

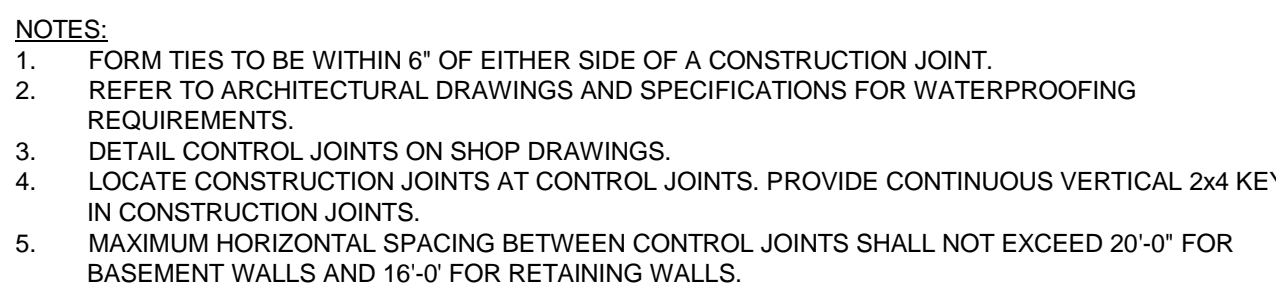

CONSULTANTS:

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www.thpltd.com

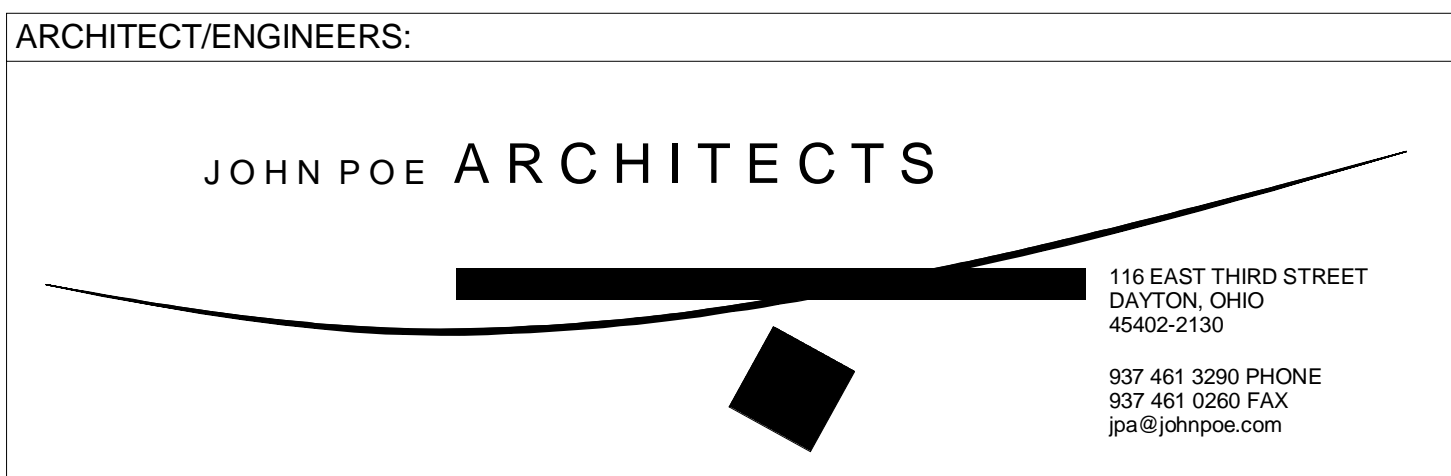

Project Title		
Renovate CLC Building 211 West		
Location		
Chillicothe, Ohio		
Date	Checked	Drawn
Sept. 6, 2013	MCC	MRB

Project No.
VA Project No. 538-107
JPA Project No. 11001.00

Building Number
211

Drawing Number
S003

Dwg.47 of 132

Office of
Construction
and Facilities
Management

 Department of
Veterans Affairs

FULLY SPRINKLERED

- DRAWING NOTES:
- REFER TO S001 SERIES FOR GENERAL NOTES AND TYPICAL DETAILS.
 - REFER TO S200 SERIES FOR FOUNDATION DETAILS.
 - ELEVATION: 100'-0" = 703.15'


- KEY NOTES: (X)
- REFER TO ARCH. FOR WALL OPENINGS.
 - PROVIDE CONTROL JOINTS IN SLAB ON GRADE AT 16'-0" MAX. EACH WAY, U.N.O.
 - CONNECT PEDESTALS WITH 12" WIDE CONCRETE WALL. REINFORCE WALL WITH #5 AT 12" E.W., E.F. T/WALL + T/PEDESTAL. DOWELS INTO TOP OF FOOTING TO MATCH VERTICAL WALL STEEL.
 - REFER TO MECHANICAL DRAWINGS FOR LOCATION OF BREAK IN SLAB ALLOWING PLACEMENT OF FUTURE SANITARY LINE. PROVIDE KEYED CONSTRUCTION JOINT FOR FUTURE SLAB PLACEMENT.
 - PROVIDE 12" THICKENED SLAB BELOW STAIR LANDING SUPPORT POST. REFER TO TYPICAL DETAIL ON S002. COORDINATE LOCATION WITH STAIR MANUFACTURER.
 - #4 DOWELS AT 18" O.C. EPOXY EMBED 6" INTO EXISTING CONCRETE. INSTALL WATERSTOP RX BEAD BETWEEN NEW AND EXISTING BASEMENT WALLS.
 - THICKEN S.O.G. BELOW COLUMN FOR A 2'-0"x2'-0" AREA, TOTAL DEPTH=24".
 - ADD (2) #8 TO SLAB. EXTEND 2'-0" BEYOND OPENING EDGE.
 - DO NOT DAMAGE EXISTING BASEMENT WALL OR FOUNDATIONS TO REMAIN WHILE REMOVING PORTIONS REQUIRED IN THE ARCHITECTURAL DRAWINGS.

- LEGEND:
- INDICATES WALL CONTROL JOINT
 - INDICATES FOOTING STEP. REFER TO TYPICAL DETAIL ON S002.
 - INDICATES FOOTING MARK. REFER TO SCHEDULE BELOW.
 - INDICATES TYPE OF PEDESTAL.
 - INDICATES TOP OF FOOTING ELEVATION.
 - INDICATES TOP OF PEDESTAL ELEVATION.

FOOTING SCHEDULE			
MARK	SIZE	THICKNESS	REINFORCING
A	6"x6"	24"	(7) #6 EW
B	7"x7"	24"	(7) #6 EW
C	7"x14"	24"	(7) #6 LONG (14) #6 SHORT
D	8"x8"	24"	(7) #7 EW
E	9"x9"	36"	(12) #7 EW
F	10"x10"	36"	(13) #7 EW
G	5"x10"	24"	(10) #6 LONG (9) #6 SHORT
H	7"x10"	24"	(7) #7 LONG (9) #7 SHORT
J	6"x11"	24"	(10) #6 LONG (8) #6 SHORT
K	6"x8'-6"	24"	(8) #6 LONG (9) #6 SHORT

1 FOUNDATION PLAN
1/8" = 1'-0"

NOTE:
FIELD VERIFY EXISTING FOOTING LOCATIONS. LOCATIONS SHOWN ARE INTERPRETED FROM THE ORIGINAL BUILDING DRAWINGS AND MAY VARY FROM ACTUAL CONDITIONS. NEW FOOTINGS ADJACENT TO EXISTING FOOTING SHOULD BEAR AT SAME ELEVATION AS EXISTING. NOTIFY ENGINEER IF DEVIATION IS MORE THAN 0'-9".

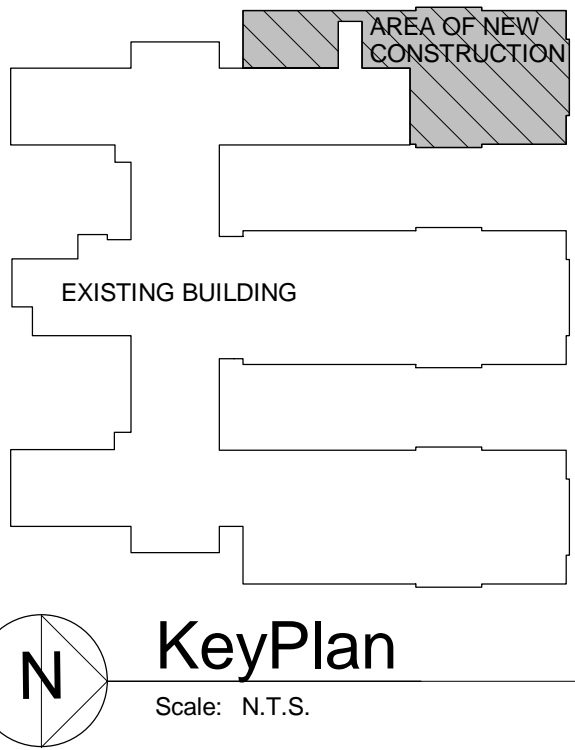

1

Bid Documents

9/6/13

Date

2

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ARCHITECT/ENGINEERS:

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jpa@johnpoe.com

4

Drawing Title

FOUNDATION PLAN

Approved: Project Director

5

Project Title

Renovate CLC
Building 211 West

Location
Chillicothe, Ohio

Date
Sept. 6, 2013

Checked
MCC

Drawn
MRB

6

Project No.

VA Project No. 538-107
JPA Project No. 11001.00

Building Number
211

Drawing Number
S100

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7

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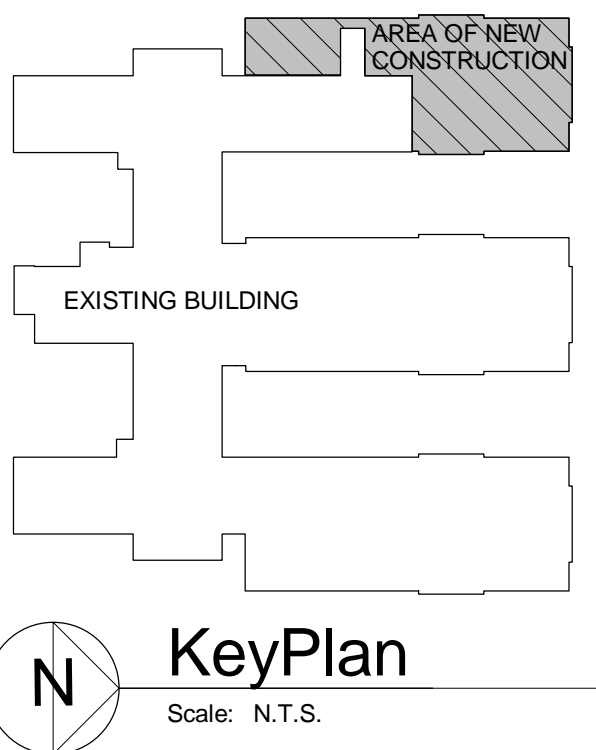
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FULLY SPRINKLERED

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 - SLABS ARE TO BE CAST LEVEL, WITH MINIMUM THICKNESS SHOWN ON DRAWINGS. PROVIDE AN ASSUMED EXTRA 1/4" OF CONCRETE TO ACCOUNT FOR METAL DECK AND BEAM DEFLECTION. PURLINS AND GIRDERS ARE UNSHORED DURING SLAB PLACEMENT. AFTER PLACEMENT, FINISH SLABS TO REQUIRED TOLERANCES, REFER TO SPECIFICATIONS.
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 - REFER TO DRAWING S501 FOR STEEL COLUMN SCHEDULE.
 - REFER TO DRAWING S401 FOR VERTICAL BRACING ELEVATIONS AND DETAILS.
 - REFER TO DRAWING S002 FOR TYPICAL BEAM POCKET DETAIL.
 - COORDINATE DUCT AND FIRE DAMPER SLEEVED OPENINGS WITH ARCHITECTURAL AND MECHANICAL REQUIREMENTS.

- KEY NOTES: (X)
- PROPOSED DAMPER/DUCT LOCATION. OPENING LOCATION AND SLAB FRAMING MUST BE COORDINATED WITH STRUCTURAL ENGINEER PRIOR TO SLAB PLACEMENT.
 - EMBED PLATE CONNECTION ABOVE DOORWAY. REFER TO TYPICAL EMBEDDED PLATE DETAIL ON S003.




<div>1</div> <div>Bid Documents</div> <div>9/6/13</div> <div>Date</div>		<div>CONSULTANTS:</div> <div><div>THP</div><div>THP Limited, Inc. 100 East Eighth Street Cincinnati, Ohio 45202 Phone: 513.241.3222 Fax: 513.241.2981 www.thpltd.com</div></div>		<div>ARCHITECT/ENGINEERS:</div> <div><div>JOHN POE ARCHITECTS</div><div>116 EAST THIRD STREET DAYTON, OHIO 45402-2130 937.461.3280 PHONE 937.461.0280 FAX jpa@johnpoe.com</div></div>		<div>Drawing Title</div> <div>LEVEL 1 FRAMING PLAN</div> <div>Approved: Project Director</div>		<div>Project Title</div> <div>Renovate CLC Building 211 West</div> <div>Location Chillicothe, Ohio</div> <div>Date Sept. 6, 2013</div> <div>Checked MCC</div> <div>Drawn MRB</div>		<div>Project No.</div> <div>VA Project No. 538-107 JPA Project No. 11001.00</div> <div>Building Number</div> <div>211</div> <div>Drawing Number</div> <div>S101</div> <div>Dwg. 49 of 132</div>		<div>Office of Construction and Facilities Management</div> <div>Department of Veterans Affairs</div>	
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1 LEVEL 1 FRAMING PLAN
1/8" = 1'-0"


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1 LEVEL 2 FRAMING PLAN
1/8" = 1'-0"




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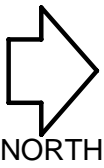
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- PROPOSED DAMPER/DUCT LOCATION, OPENING LOCATION AND SLAB FRAMING MUST BE COORDINATED WITH STRUCTURAL ENGINEER PRIOR TO SLAB PLACEMENT.
 - EMBED PLATE CONNECTION ABOVE DOORWAY. REFER TO TYPICAL EMBEDDED PLATE DETAIL ON S003.

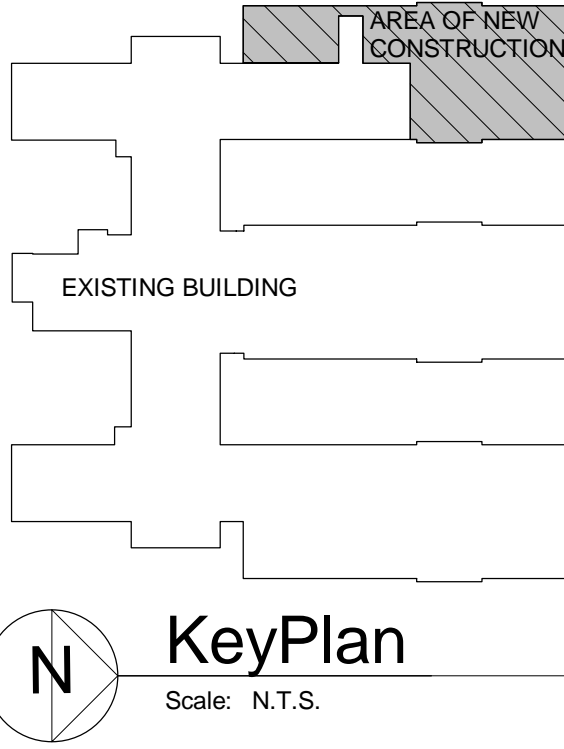

<div>1</div> <div>Bid Documents</div> <div>9/6/13</div> <div>Date</div>		<div>CONSULTANTS:</div> <div><div>THP</div><div>THP Limited, Inc. 100 East Eighth Street Cincinnati, Ohio 45202 Phone: 513.241.3222 Fax: 513.241.2981 www.thpltd.com</div></div>		<div>ARCHITECT/ENGINEERS:</div> <div><div>JOHN POE ARCHITECTS</div><div>116 EAST THIRD STREET DAYTON, OHIO 45402-2130 937 461 3280 PHONE 937 461 0280 FAX jpa@johnpoe.com</div></div>		<div>Drawing Title</div> <div>ATTIC LEVEL FRAMING PLAN</div> <div>Approved: Project Director</div>		<div>Project Title</div> <div>Renovate CLC Building 211 West</div> <div>Location Chillicothe, Ohio</div> <div>Date Sept. 6, 2013</div> <div>Checked MCC</div> <div>Drawn MRB</div>		<div>Project No.</div> <div>VA Project No. 538-107 JPA Project No. 11001.00</div> <div>Building Number</div> <div>211</div> <div>Drawing Number</div> <div>S103</div> <div>Dwg. 51 of 132</div>		<div>Office of Construction and Facilities Management</div> <div>Department of Veterans Affairs</div>	
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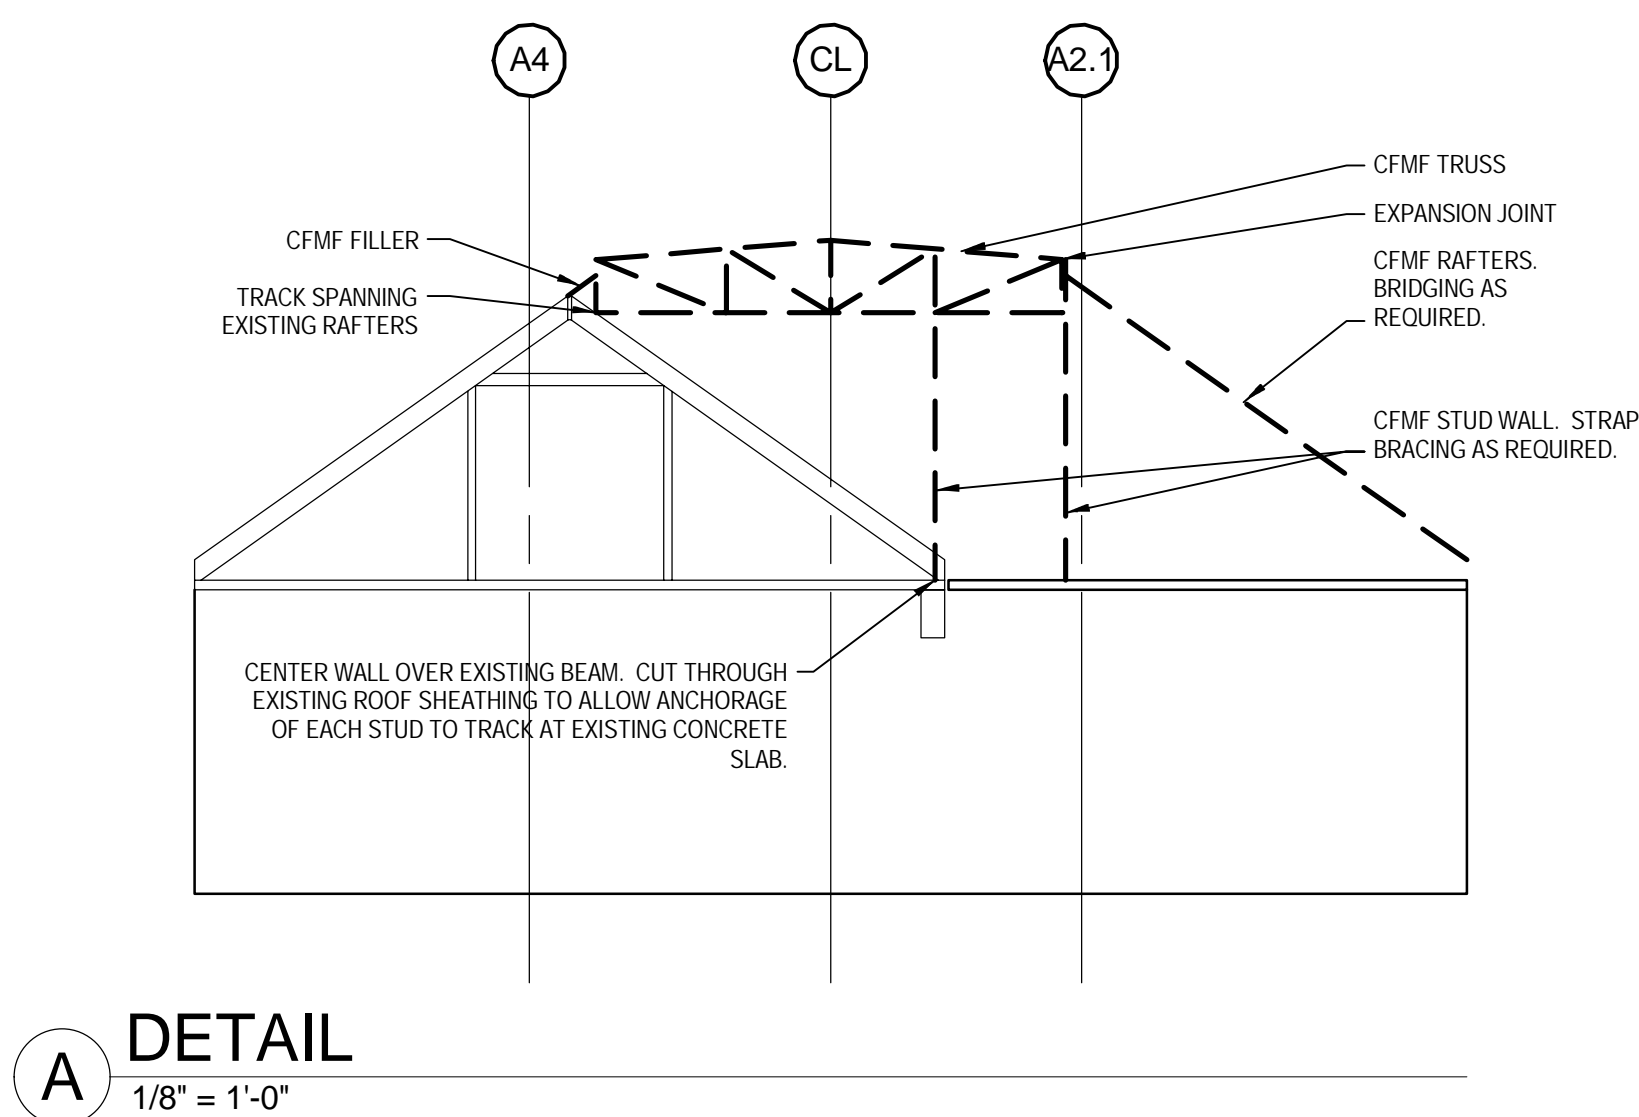
1 ATTIC LEVEL FRAMING PLAN
1/8" = 1'-0"

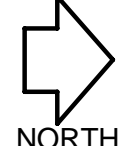


1. LAYOUT SHOWN IS FOR SCHEMATIC PURPOSES ONLY. FINAL FRAMING LAYOUT IS THE RESPONSIBILITY OF THE CFMF FABRICATOR.
2. SIZES AND GAGES SHOWN ARE MINIMUM REQUIRED FOR THE SCHEMATIC LAYOUT SHOWN. FINAL SIZES AND GAGES TO BE PROVIDED BY CFMF FABRICATOR.
3. CFMF FABRICATOR TO DESIGN ALL CONNECTIONS. REFER TO ARCHITECTURAL DRAWINGS FOR WORK POINT AND ROOF SLOPE INFORMATION AND FOR EXTENT OF EXISTING ROOFING DEMOLITION AND REMO

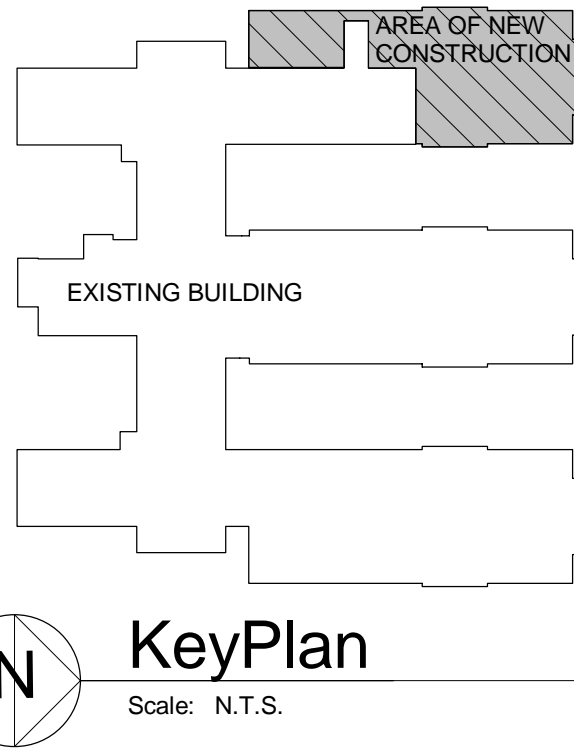1. EXISTING ROOF TO REMAIN.
2. 10" 14 GA. MINIMUM CFMF RAFTERS AT 24" O.C. PROVIDE BRIDGING AS REQUIRED.
3. CFMF TRUSSES AT 24" O.C. PROVIDE BRIDGING AS REQUIRED.
4. CFMF TRUSS TO SUPPORT GABLE RIDGE.
5. 16" 12 GA. MINIMUM I OR BOXED SHAPED CFMF RIDGE MEMBER.
6. 16" 12 GA. MINIMUM I OR BOXED SHAPED CFMF VALLEY MEMBER.
7. CFMF WALL WITH 6" 16 GA. MINIMUM STUDS AT 24" O.C. PROVIDE STRAP BRACING AS REQUIRED.
8. PROVIDE BOXED HEADER AT WALL OPENING. COORDINATE OPENING SIZE AND LOCATION WITH MECHANICAL EQUIPMENT AND DUCTWORK.
9. EXPANSION JOINT. REFER TO ARCH.
10. CUT THROUGH EXISTING ROOF SHEATHING TO ALLOW ANCHORAGE OF WALL STUDS TO TRACK ALONG EXISTING CONCRETE SLAB.

NORTH




B DETAIL
1/8" = 1'-0"

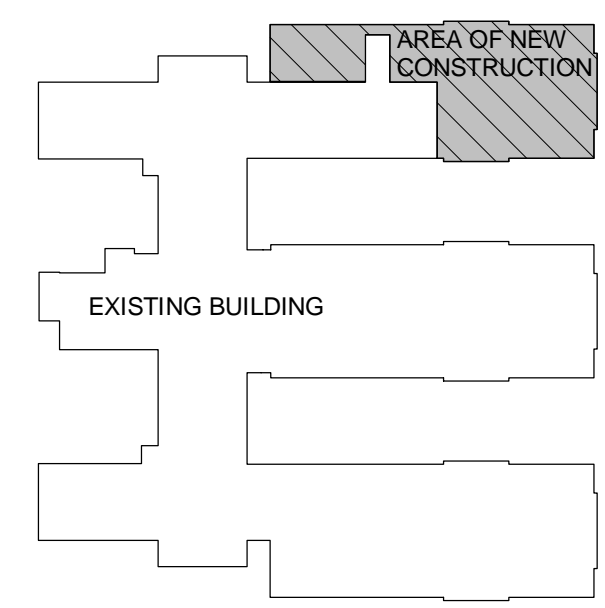

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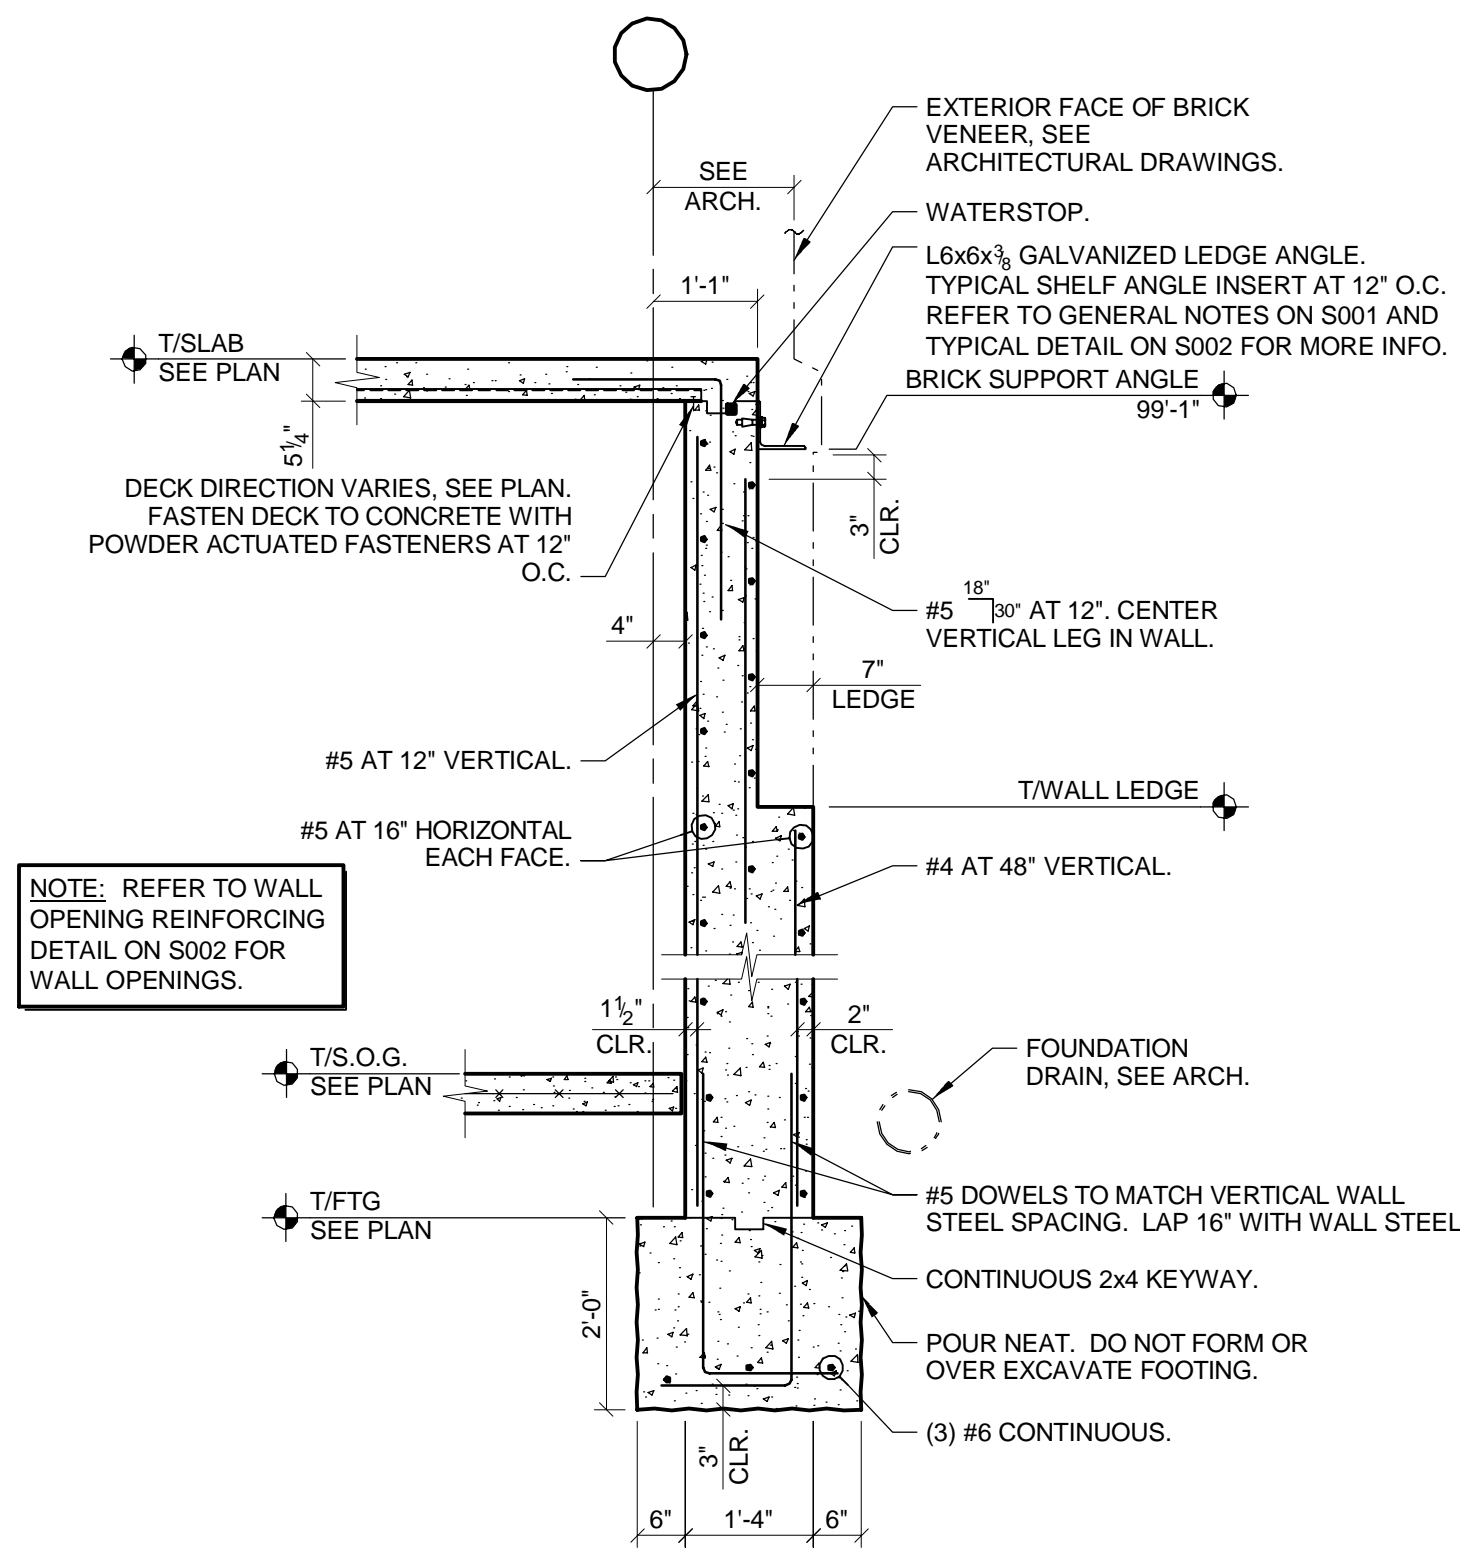


Project Title		
Renovate CLC Building 211 West		
Location		
Chillicothe, Ohio		
Date	Checked	Drawn
Sept. 2013	MCC	MRB


Office of
Construction
and Facilities
Management

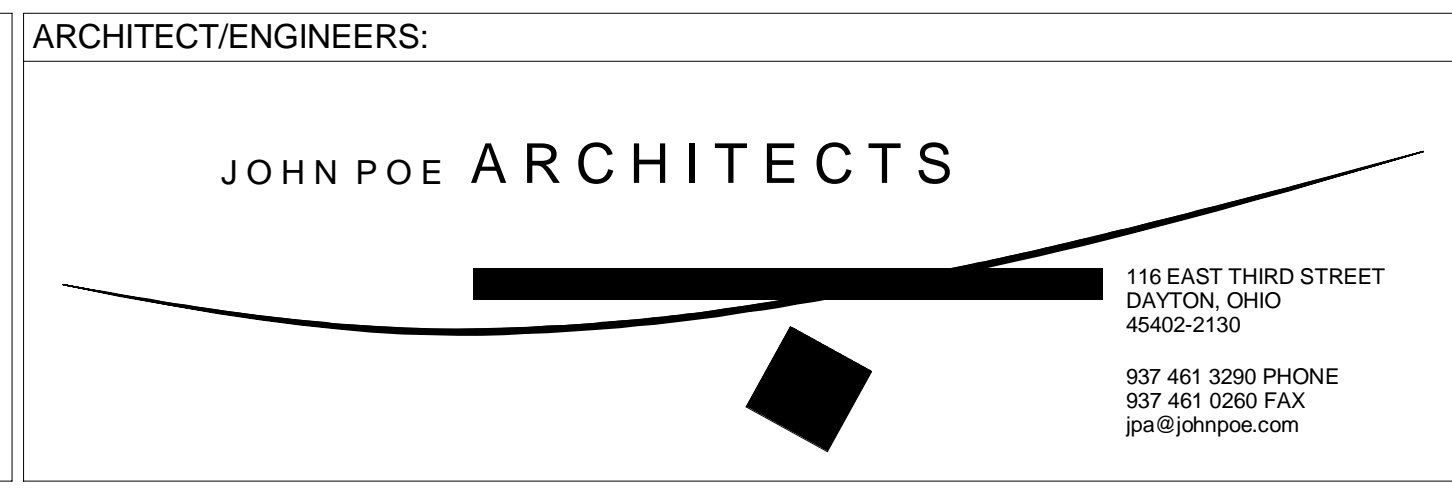 Department of
Veterans Affairs


FULLY SPRINKLERED




1
1/2" = 1'-0"

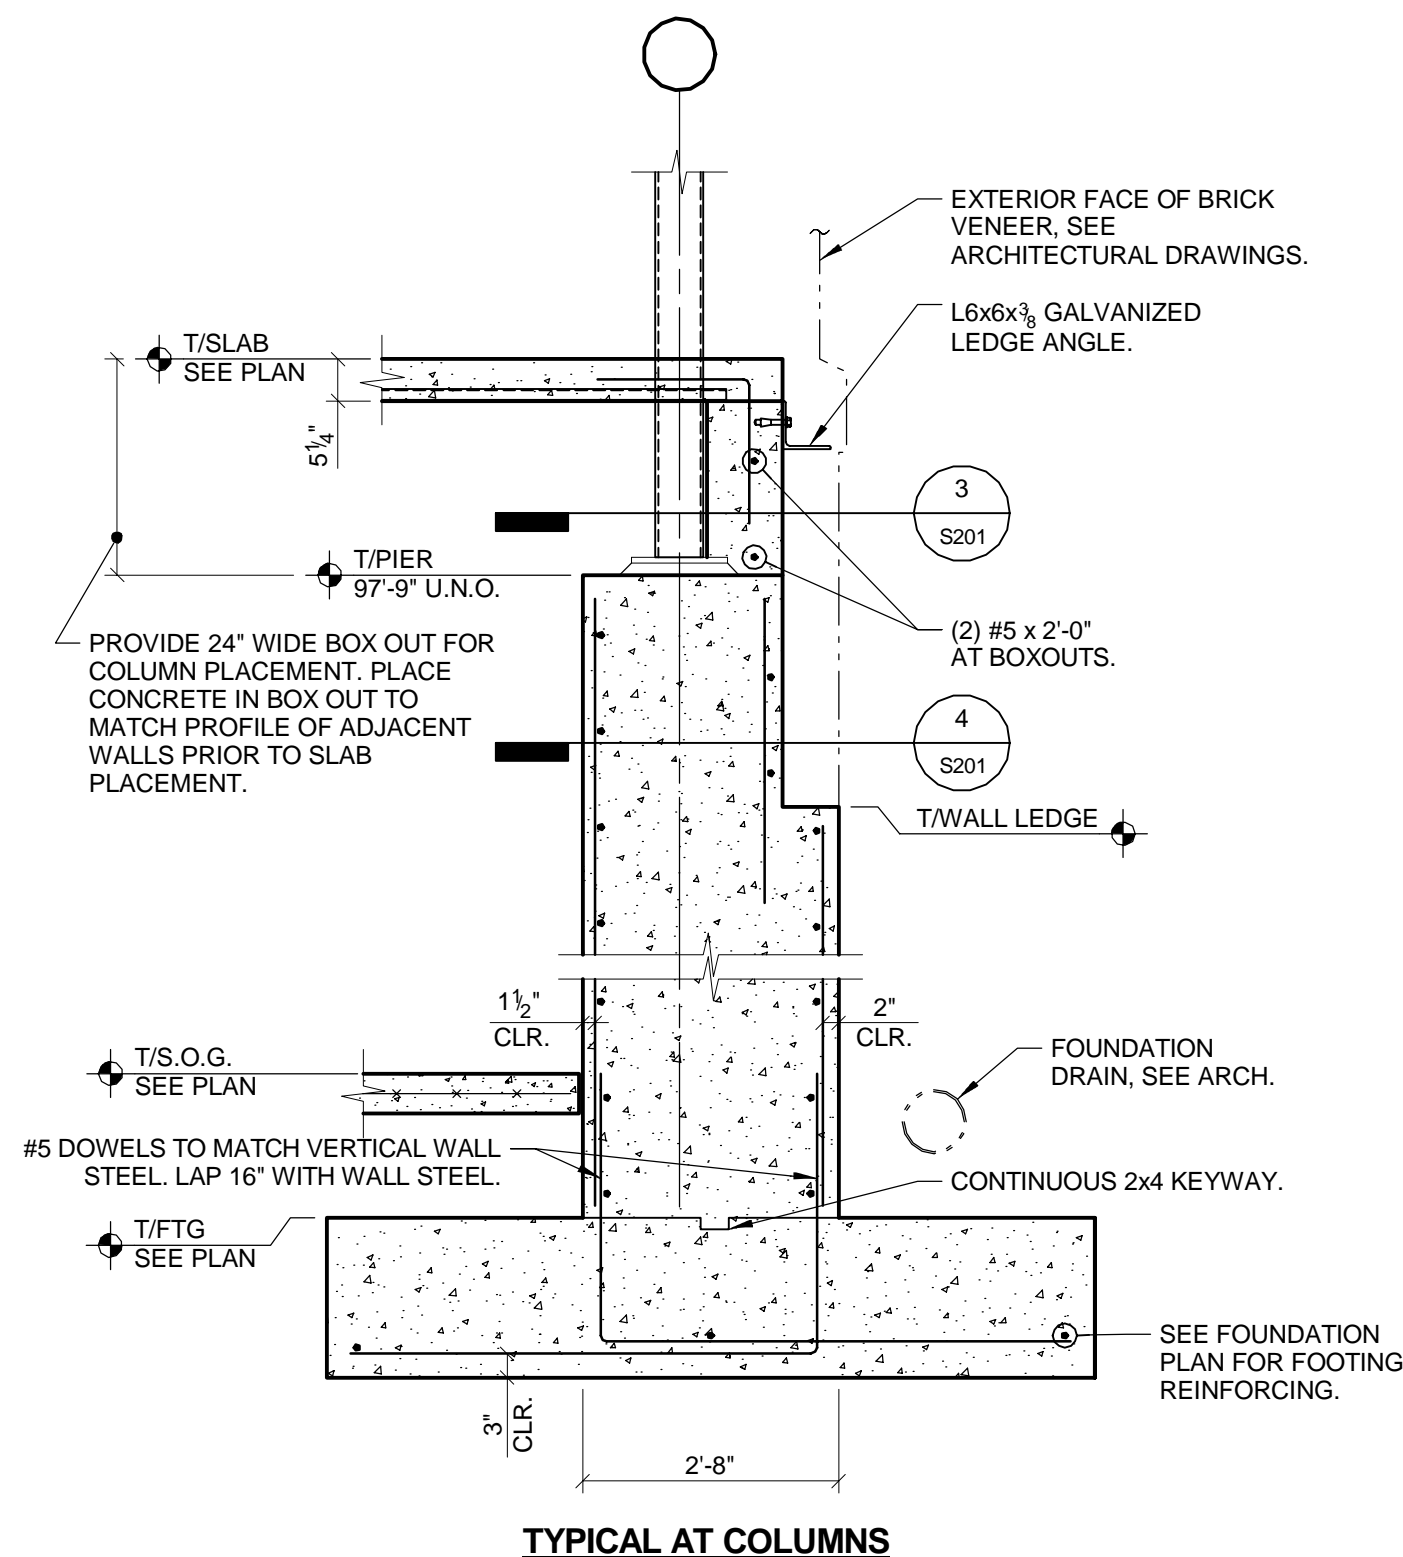


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1/2" = 1'-0"

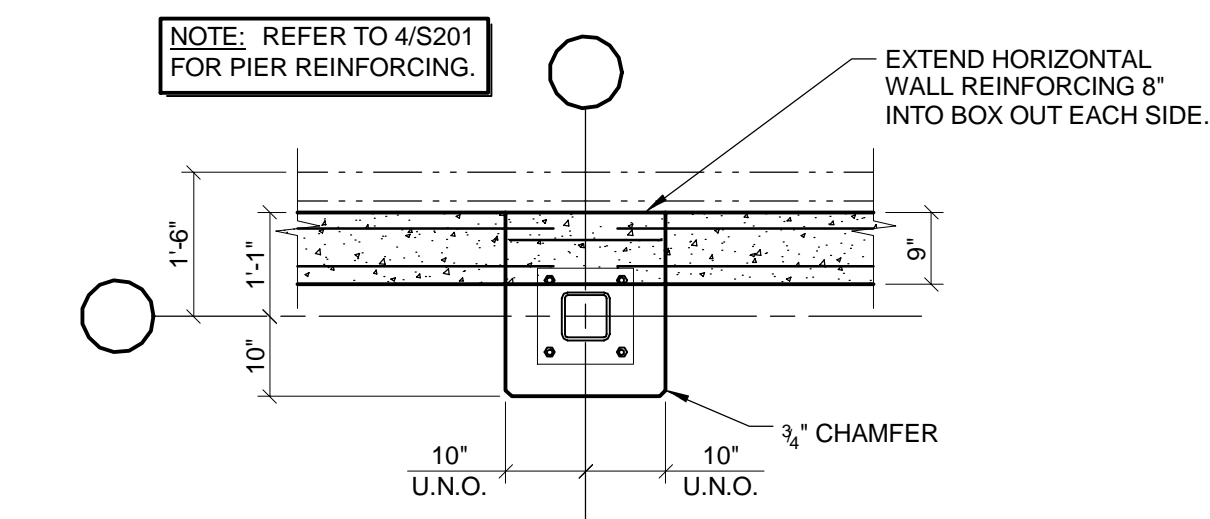


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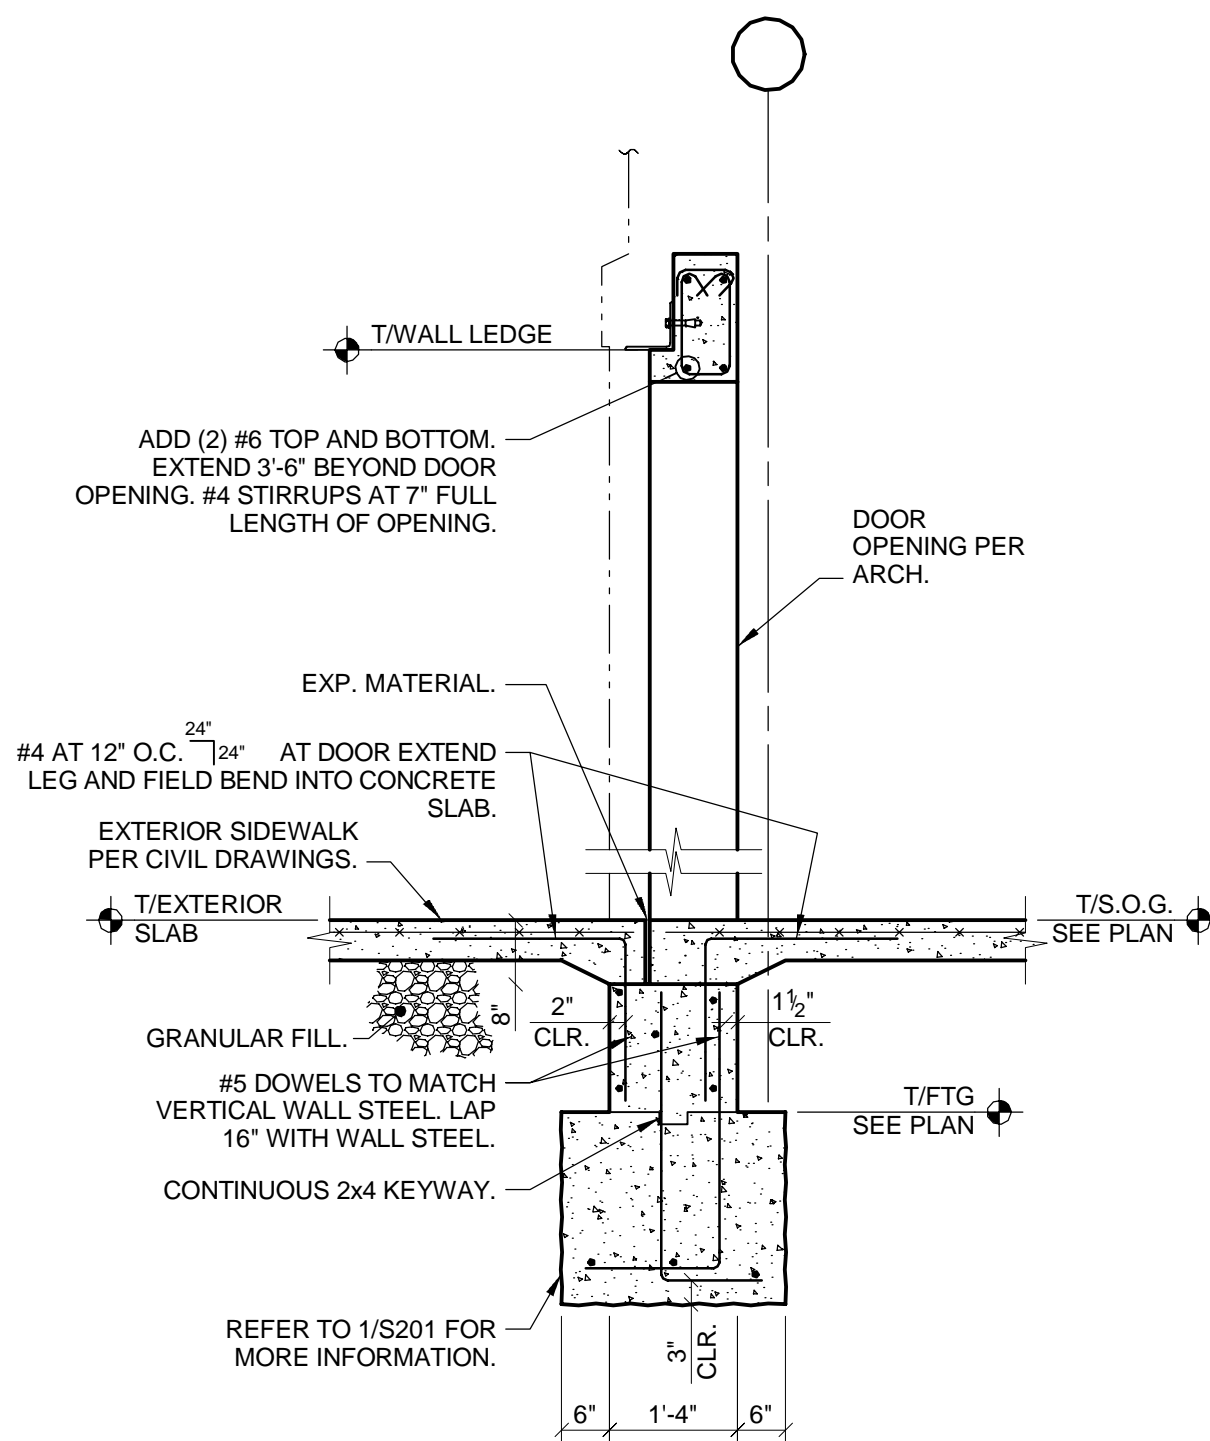
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1/2" = 1'-0"

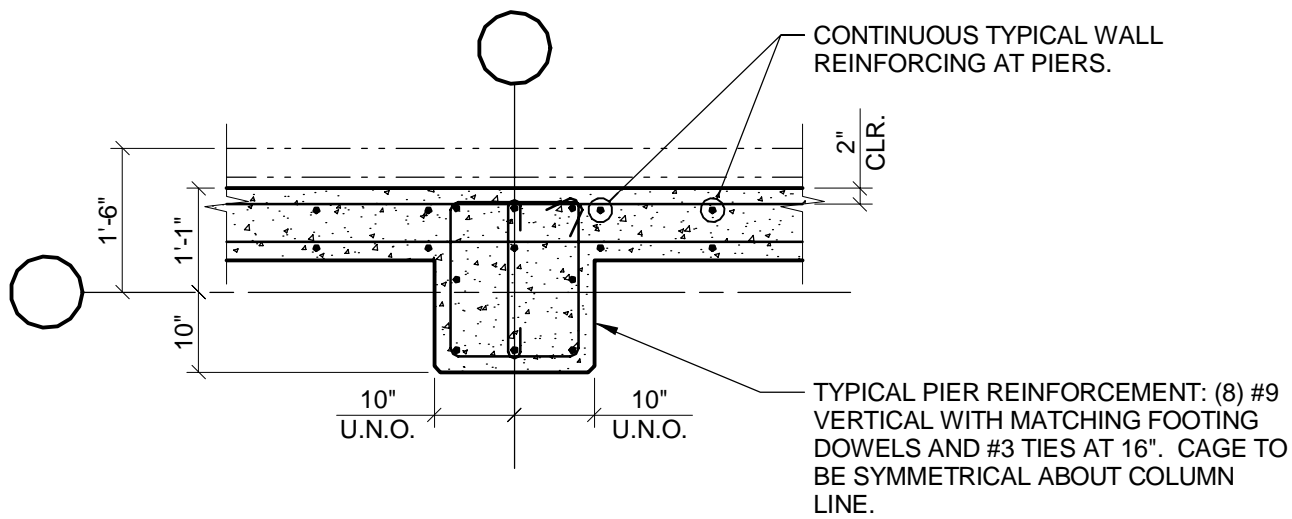


5
1/2" = 1'-0"

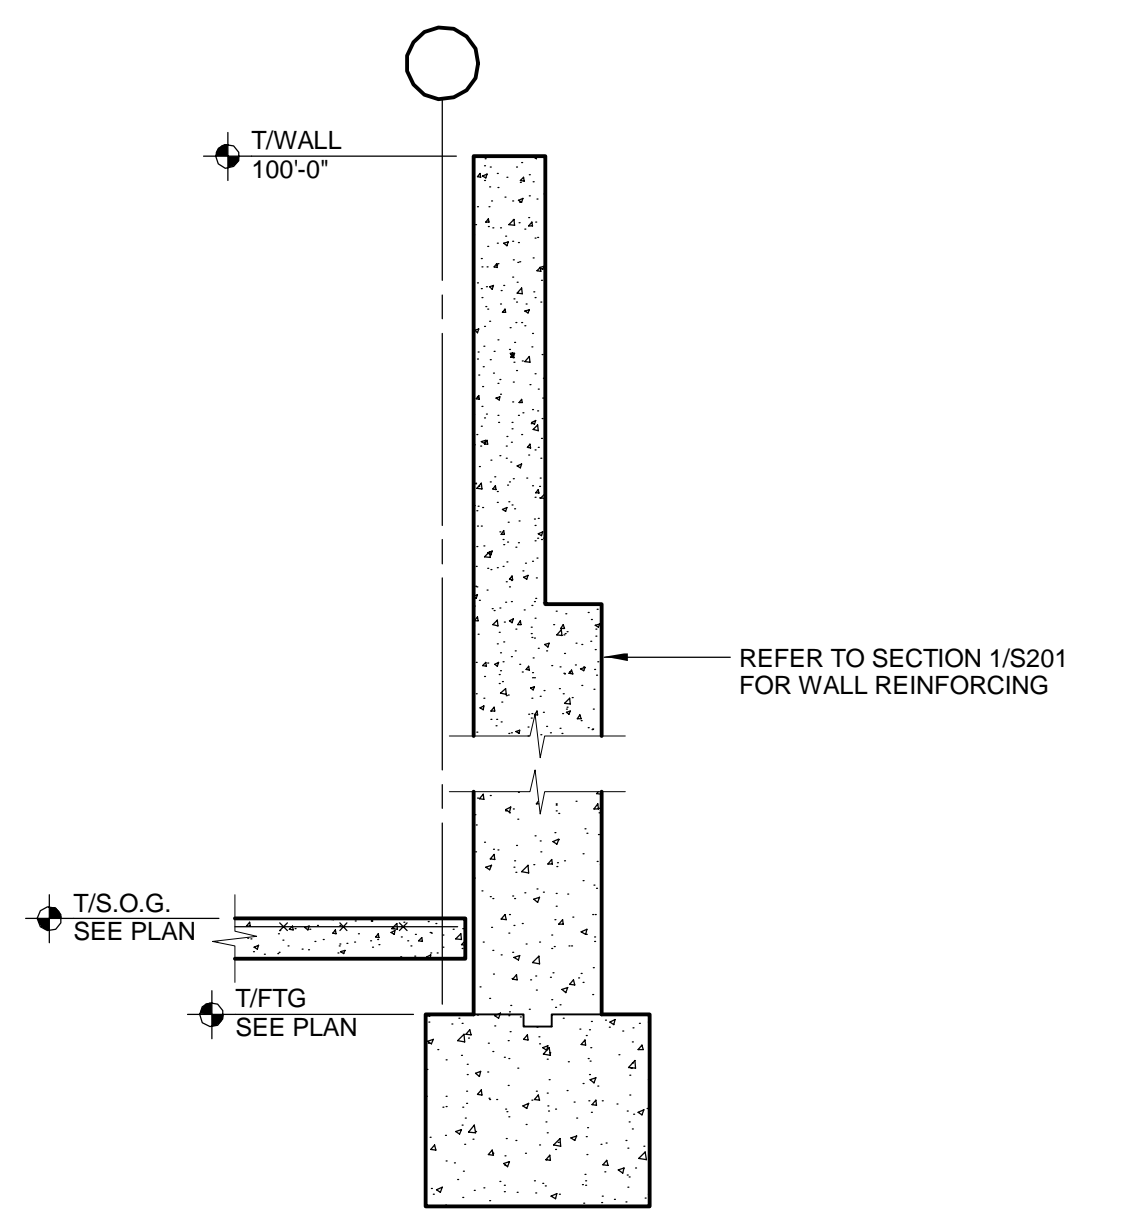


6
1/2" = 1'-0"

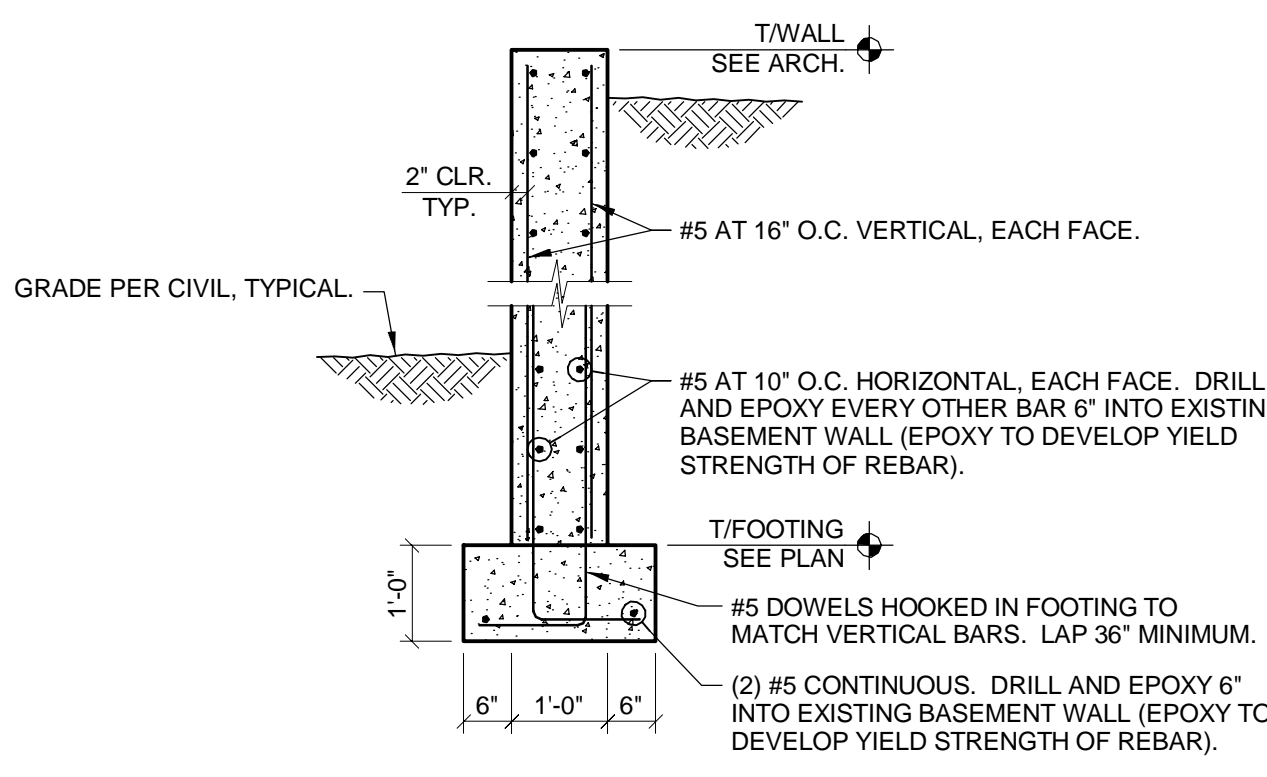

7
1/2" = 1'-0"

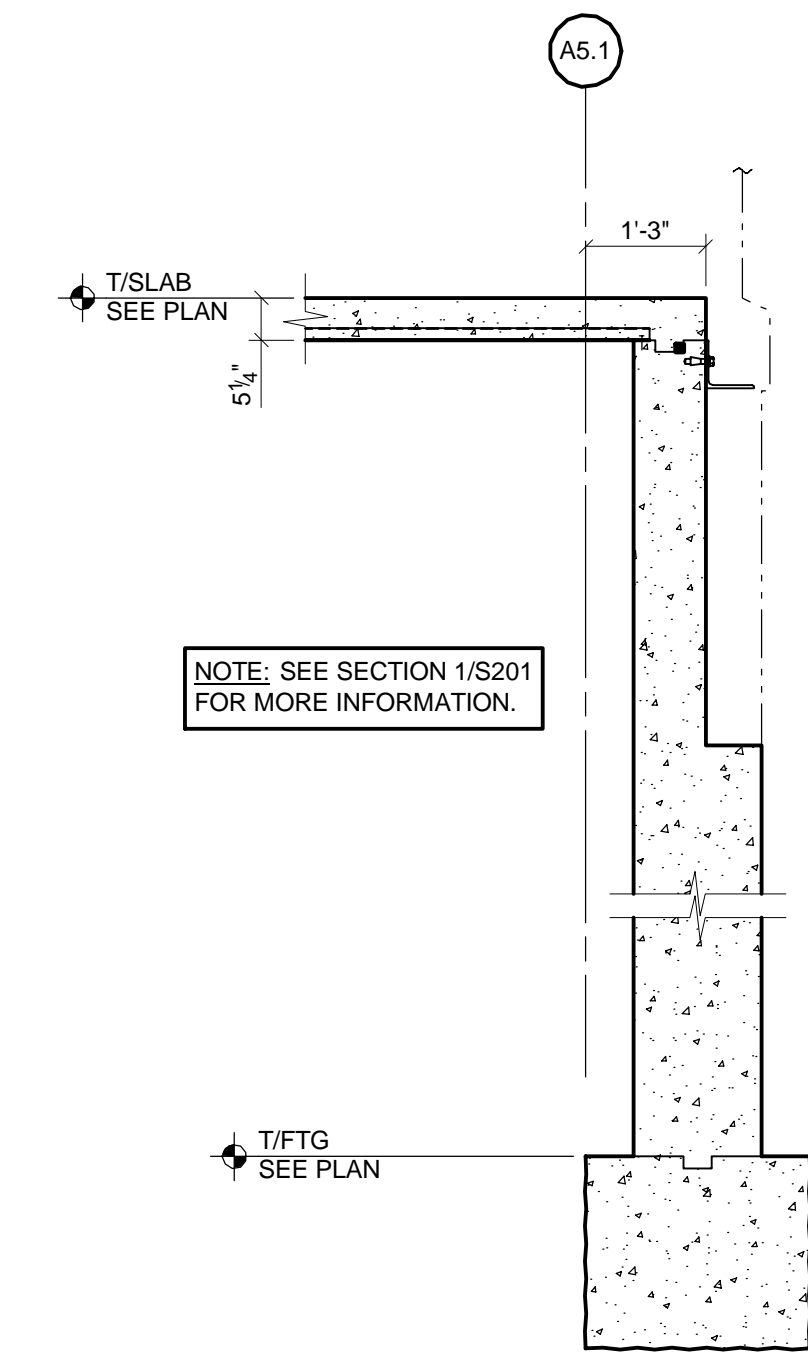

8
1/2" = 1'-0"

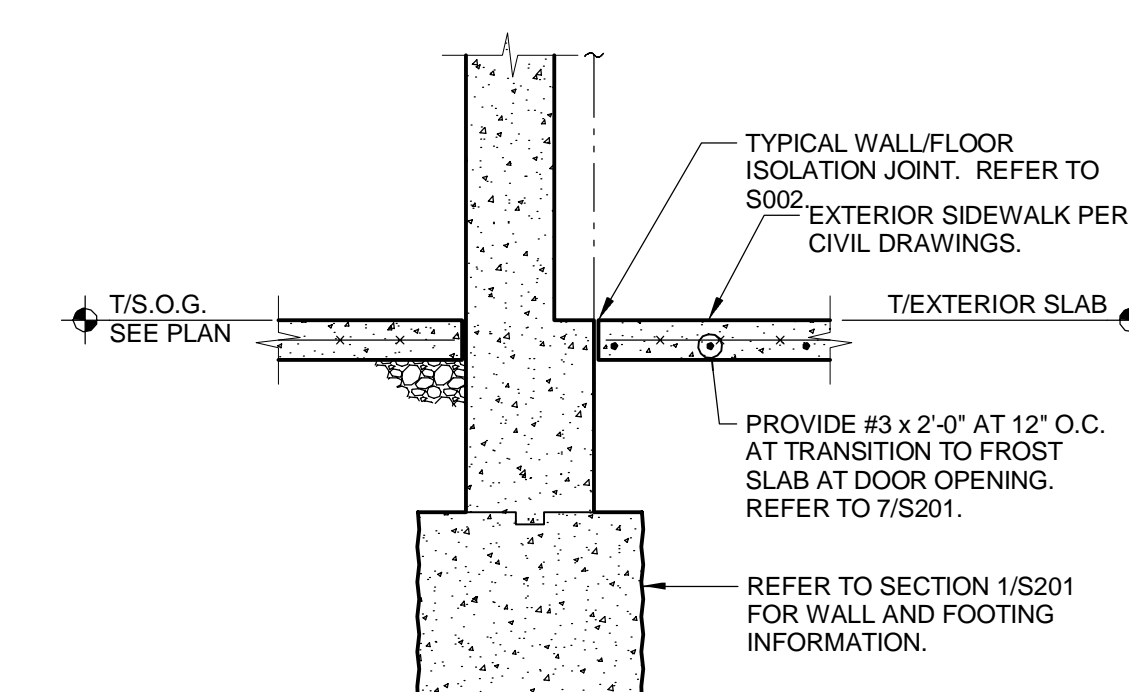

9
1/2" = 1'-0"

1	Bid Documents	9/6/13
Revisions		Date

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Drawing Title

FOUNDATION DETAILS

Approved: Project Director

Project Title

Renovate CLC Building 211 West

Location

Chillicothe, Ohio

Date

Sept. 6, 2013

Checked

MCC

Drawn

MRB

Project No.

VA Project No. 538-107
JPA Project No. 11001.00

Building Number

211

Drawing Number

S201

Dwg. 53 of 132


Office of Construction and Facilities Management

Department of Veterans Affairs


three inches = one foot
one and one-half inches = one foot
one inch = one foot
three-quarters inch = one foot
one-half inch = one foot
three-eighths inch = one foot
one-quarter inch = one foot
one-eighth inch = one foot

A
B
C
D
E
F


FULLY SPRINKLERED

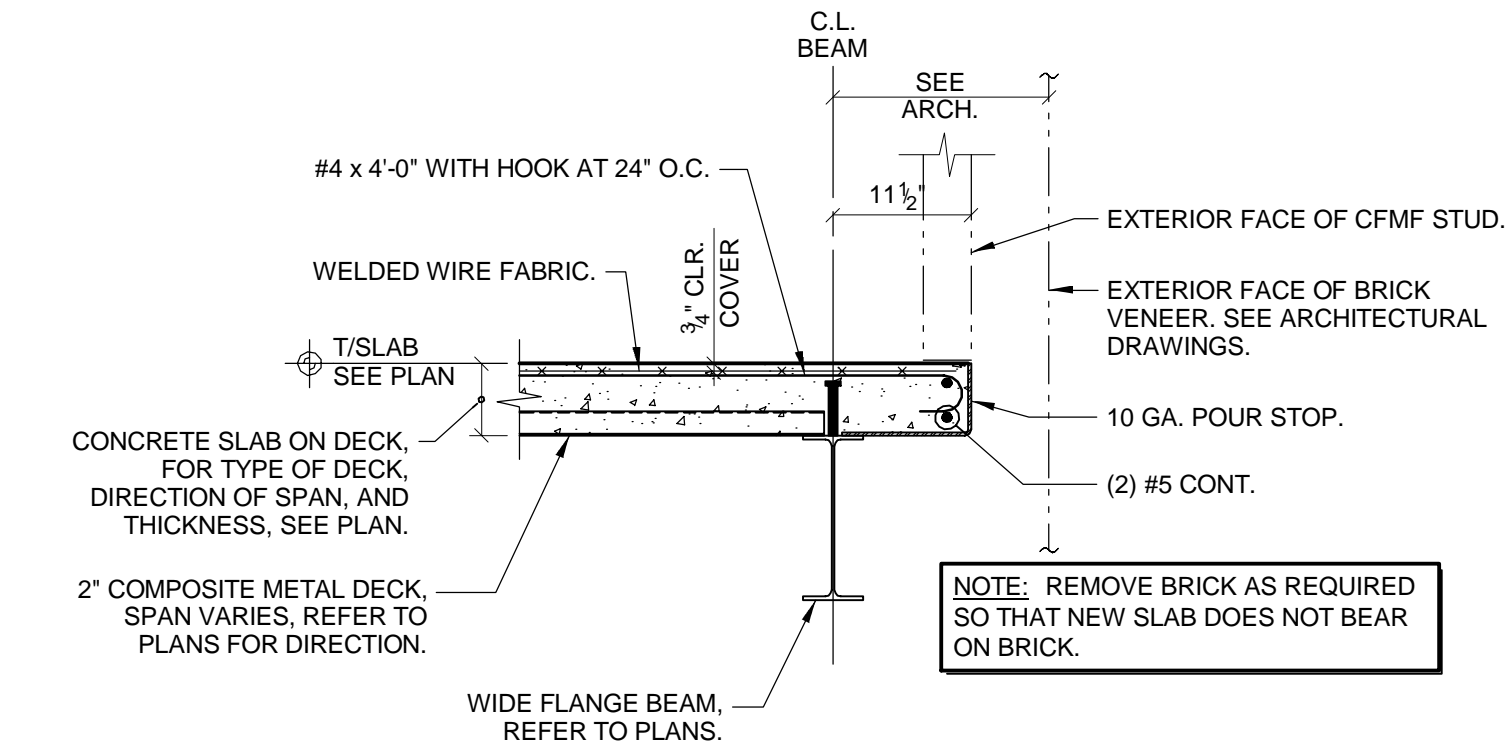


1
3/4" = 1'-0"

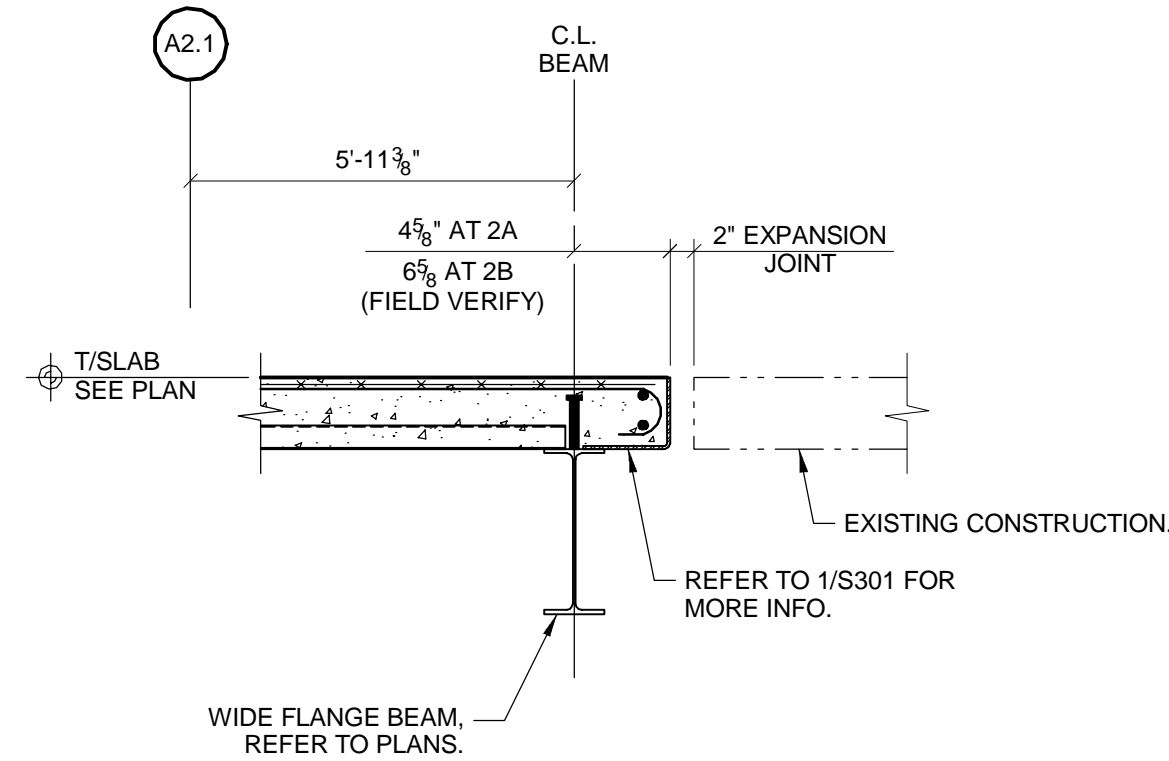

2
3/4" = 1'-0"

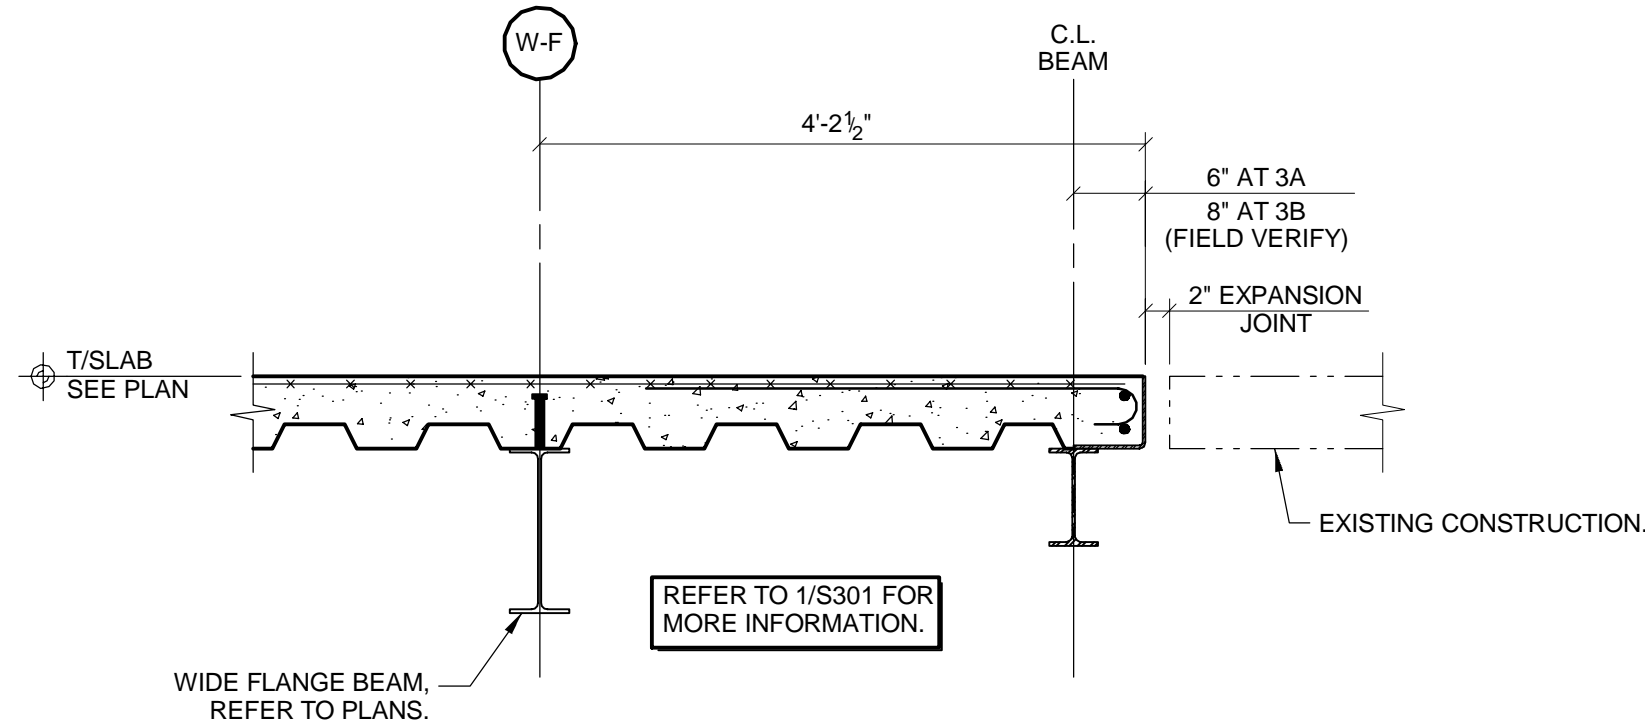

3
3/4" = 1'-0"

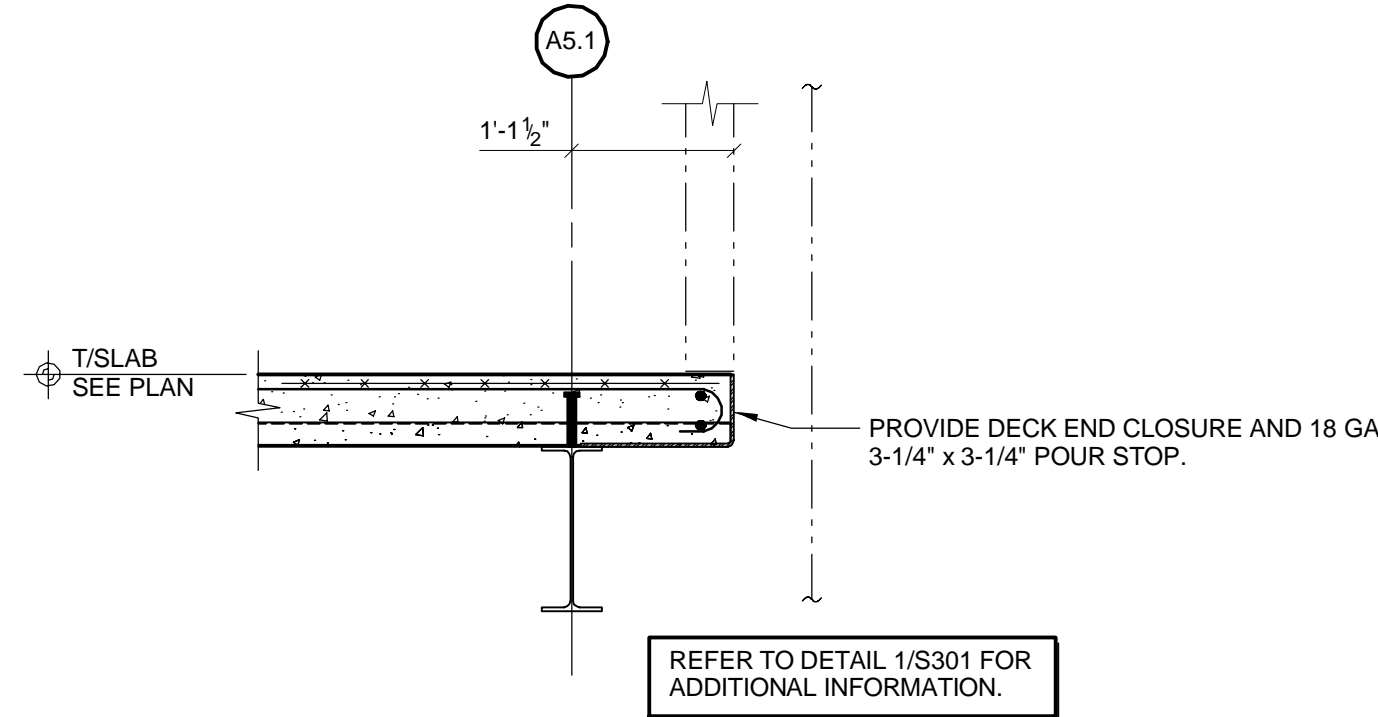


4
3/4" = 1'-0"

1	Bid Documents	9/6/13
Revisions		Date

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Drawing Title

SECTIONS

Approved: Project Director

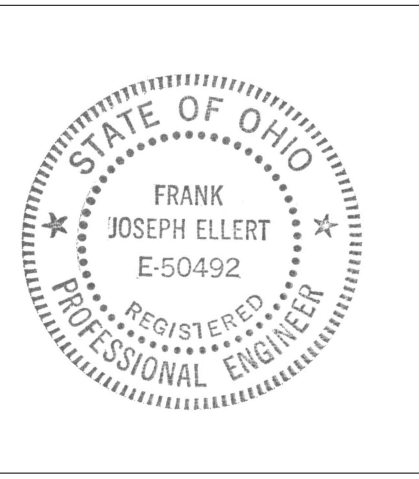Project Title

**Renovate CLC
Building 211 West**

Location

Chillicothe, Ohio

Date

Sept. 6, 2013

Project No.

VA Project No. 538-107
JPA Project No. 11001.00

Building Number

211

Drawing Number


S301

Dwg. 54 of 132


Office of
Construction
and Facilities
Management

Department of
Veterans Affairs


FULLY SPRINKLERED

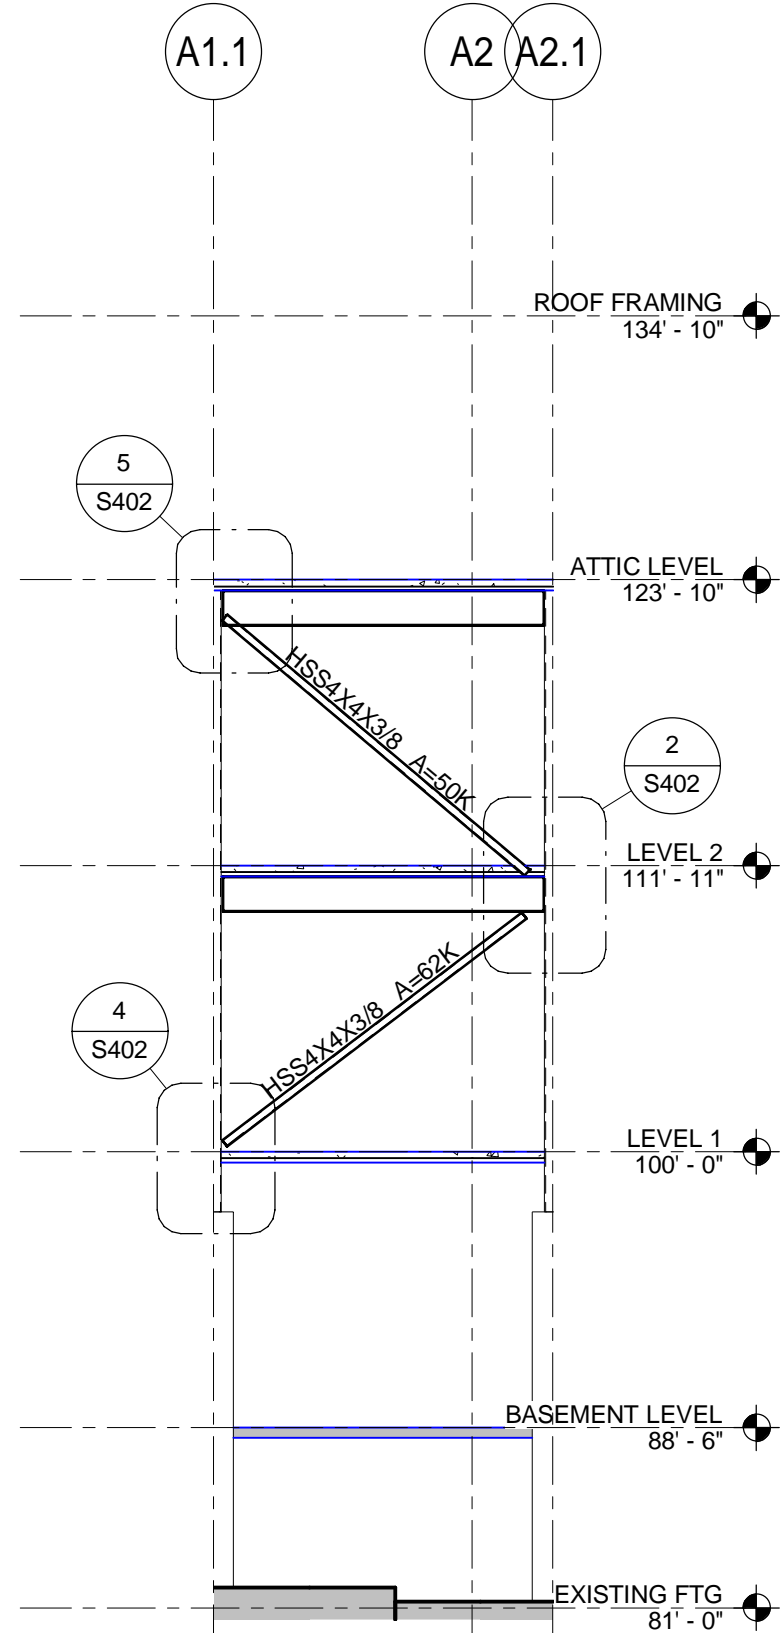


1 ELEVATION - LINE W-K
1/8" = 1'-0"

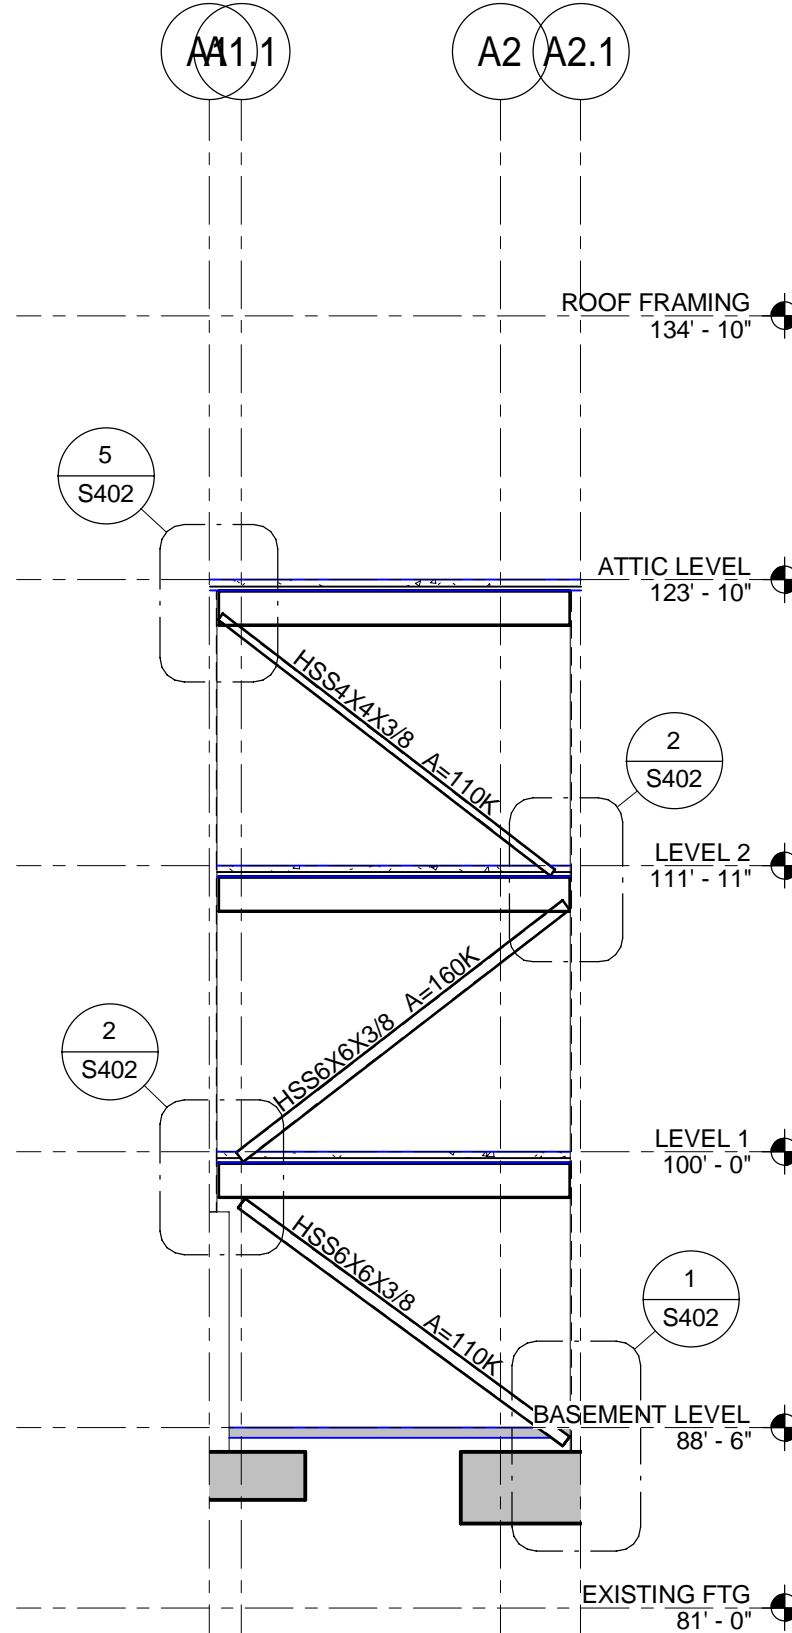


2 ELEVATION - LINE W-E
1/8" = 1'-0"

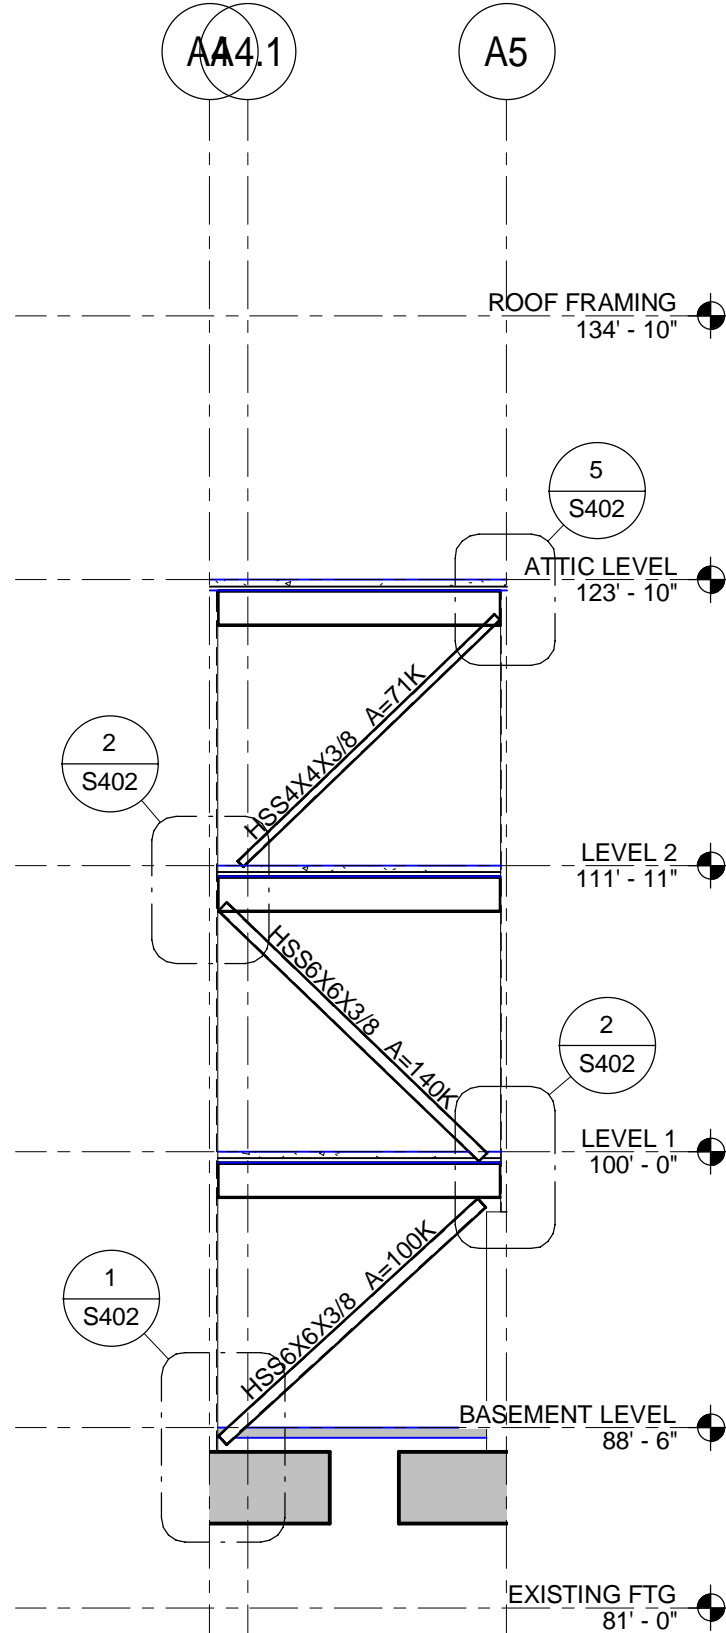


3 ELEVATION - LINE W-C
1/8" = 1'-0"

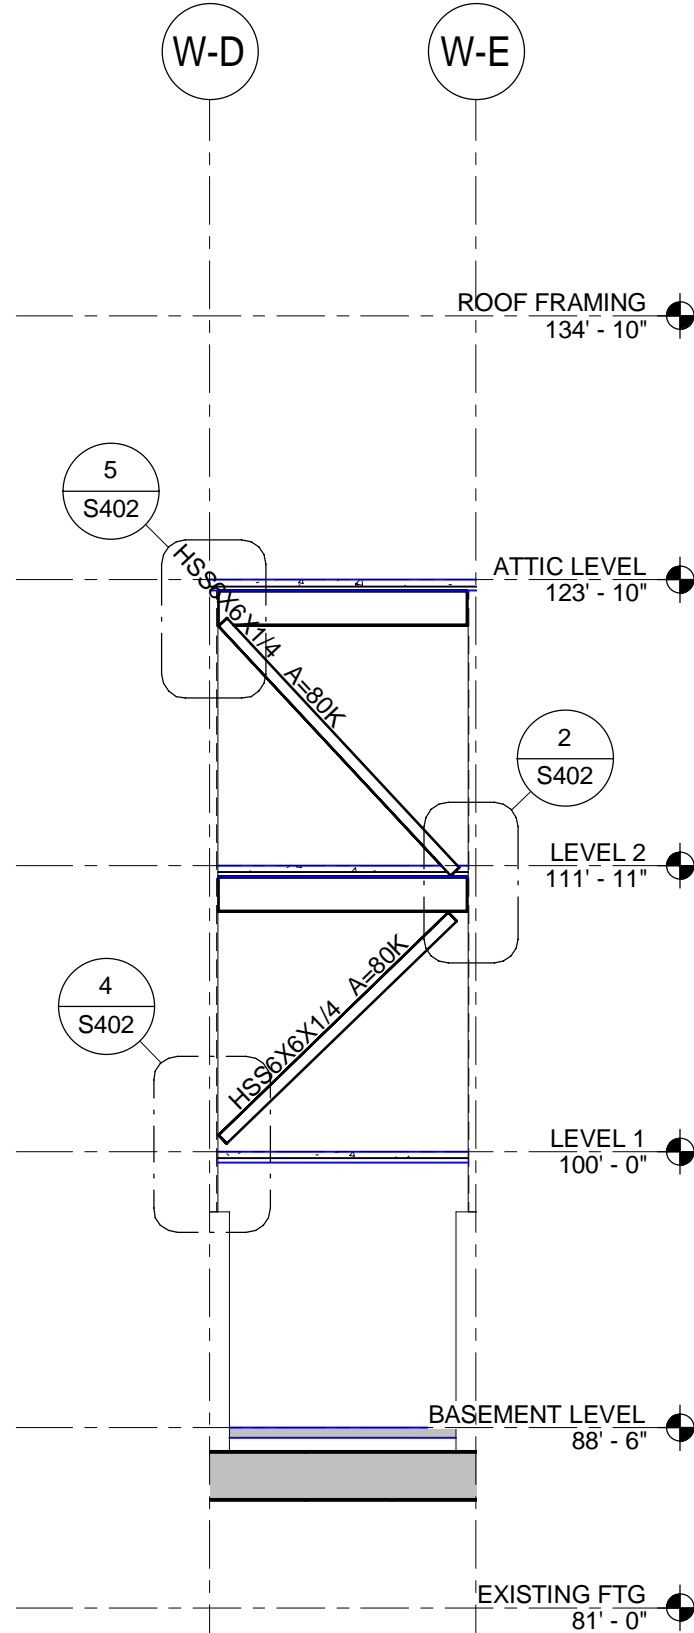


4 ELEVATION - LINE A1.1
1/8" = 1'-0"

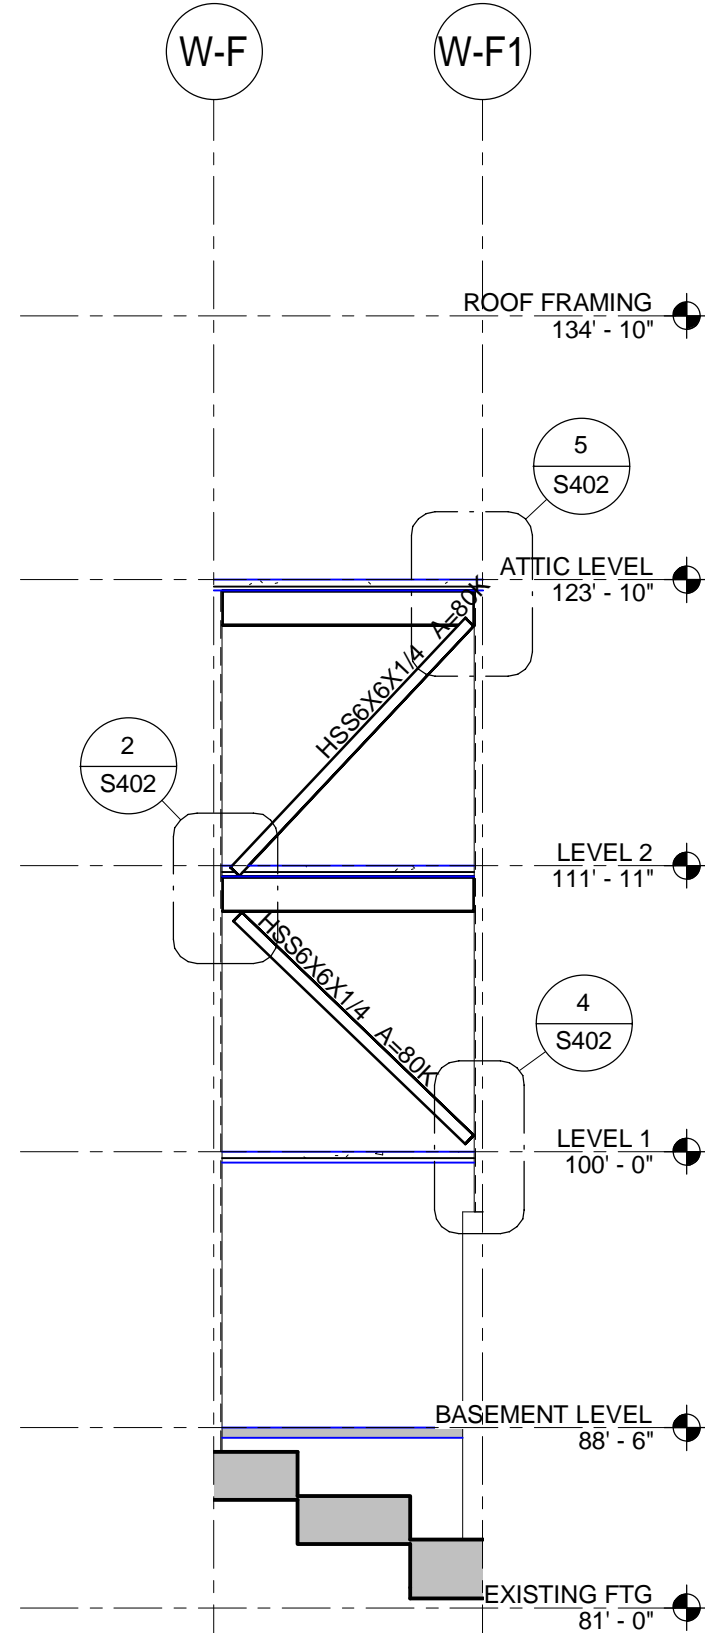

5 ELEVATION - LINE A1.1
1/8" = 1'-0"

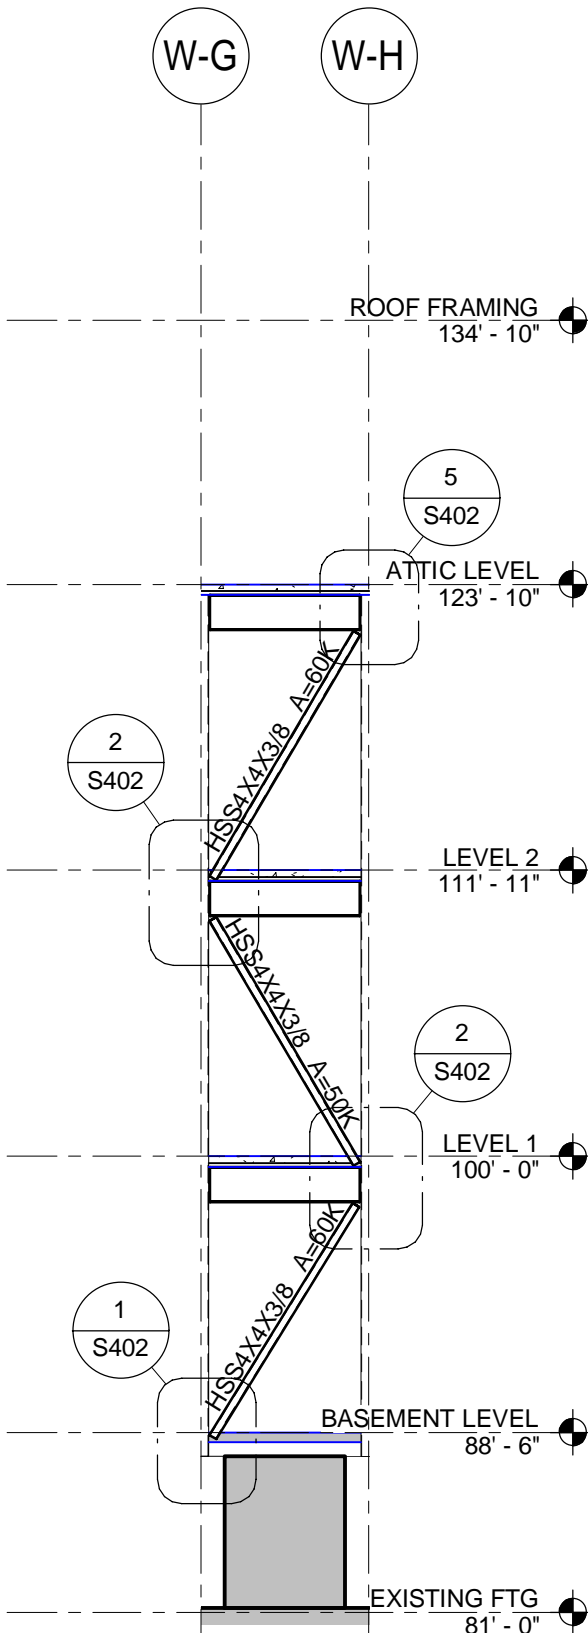

6 ELEVATION - LINE A2.1
1/8" = 1'-0"

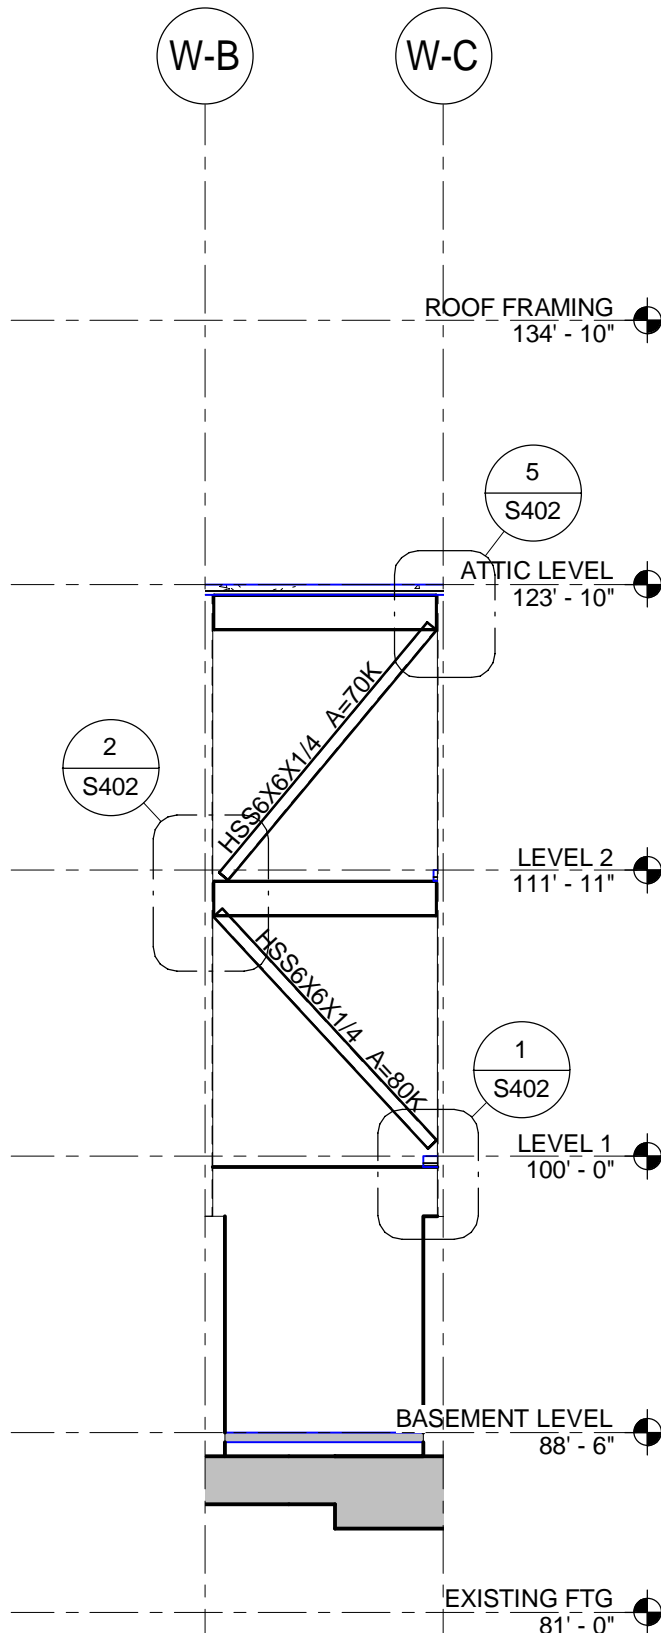

7 ELEVATION - LINE A5
1/8" = 1'-0"

1	Bid Documents	9/6/13
Revisions		Date

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Drawing Title

BRACING ELEVATIONS

Approved: Project Director

Project Title

Renovate CLC
Building 211 West

Location

Chillicothe, Ohio

Date

Sept. 6, 2013

Checked

MCC

Drawn

MRB

Project No.

VA Project No. 538-107
JPA Project No. 11001.00

Building Number

211

Drawing Number

S401

Dwg. 55 of 132

Office of
Construction
and Facilities
Management

Department of
Veterans Affairs

1 DETAIL
3/4" = 1'-0"

5 DETAIL
3/4" = 1'-0"

2 DETAIL
3/4" = 1'-0"

3 DETAIL
3/4" = 1'-0"

4 DETAIL
3/4" = 1'-0"

FULLY SPRINKLERED

Office of
Construction
and Facilities
Management

Department of
Veterans Affairs

Project No.
VA Project No. 538-107
JPA Project No. 11001.00
Building Number
211
Drawing Number
S402
Dwg. 56 of 132

Project Title
Renovate CLC
Building 211 West
Location
Chillicothe, Ohio
Date
Sept. 6, 2013
Checked
MCC
Drawn
MRB


Drawing Title
BRACING DETAILS
Approved: Project Director


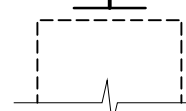
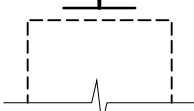
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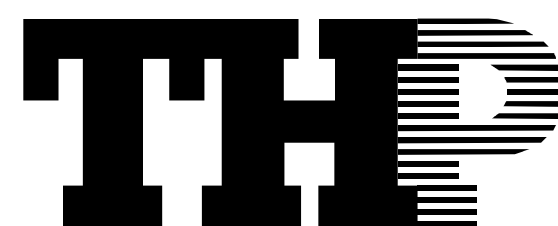


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1	Bid Documents	9/6/13
Revisions		Date



COLUMN SCHEDULE					
	C1	C2	C3	C4	C5
	A1.1/W-B A1.1/W-H A1.1/W-J A5W-D A5.1/W-F	A1.1/W-C2 A1.1/W-D A/W-E A1.1/W-F A1.1/W-F1 A1.1/W-K A2.1/W-K A5.1/W-B A5/W-C A2/W-A	A2.1/W-E	A2.1/W-C1 A2.1/W-G A2.1/W-H A2.1/W-J A4-W-C A4/W-D1 A4/W-F	A4.1/W-A
ATTIC LEVEL					
SECOND FLOOR	HSS 8x6x1/4	HSS 8x6x1/2			HSS 8x6x3/8
FIRST FLOOR			HSS 10x8x1/2	HSS 8x6x1/2	
BASEMENT LEVEL					
BASE PLATE	12"x12"x1"	14"x14"x1"	16"x14"x1 1/2"	14"x14"x1 1/2"	12"x12"x1"
ANCHOR BOLT SIZE (D)	SEE DETAIL	SEE DETAIL	SEE DETAIL	SEE DETAIL	SEE DETAIL

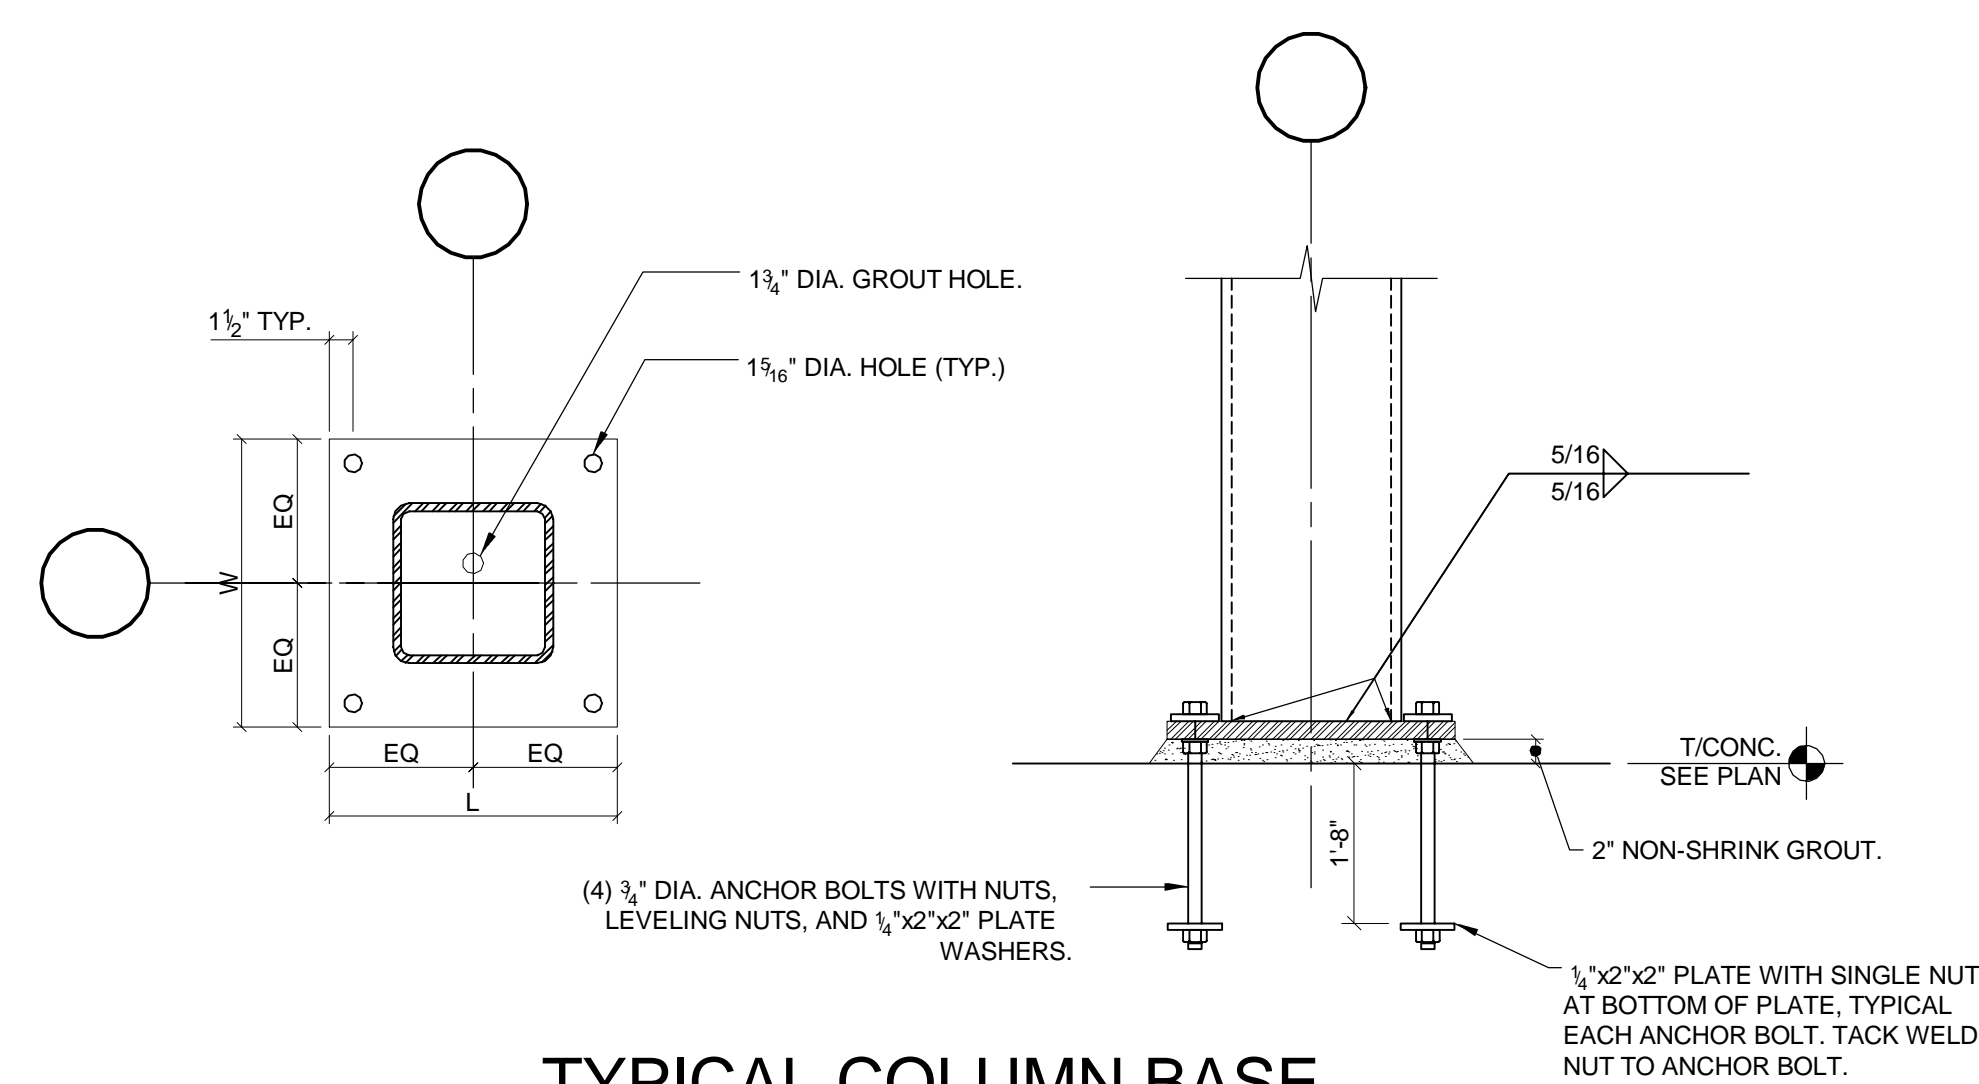

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Drawing Title

COLUMN SCHEDULE

Approved: Project Director

Project Title

Renovate CLC
Building 211 West

Location

Chillicothe, Ohio

Date

Sept. 6, 2013

☐ Checked

MCC

Drawn

MRB

Project No.	
VA Project No.	538-107
JPA Project No.	11001.00

Building Number
211


Drawing Number

S501

Dwg.57 of 132


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Management



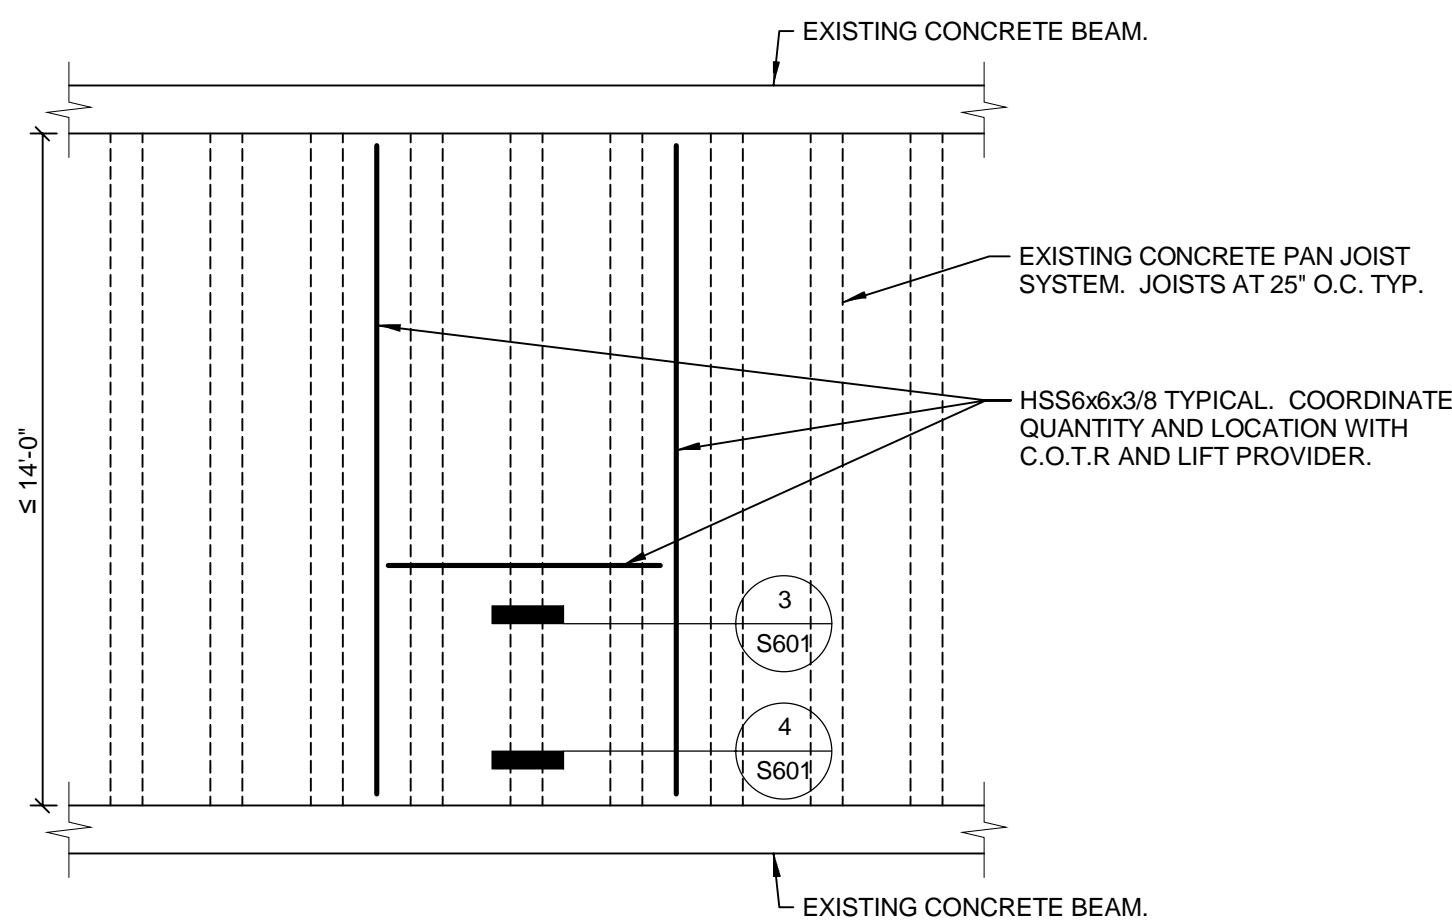

PARTIAL PLAN - TYPICAL FRAMING FOR PATIENT LIFT SYSTEM

1/4" = 1'-0"

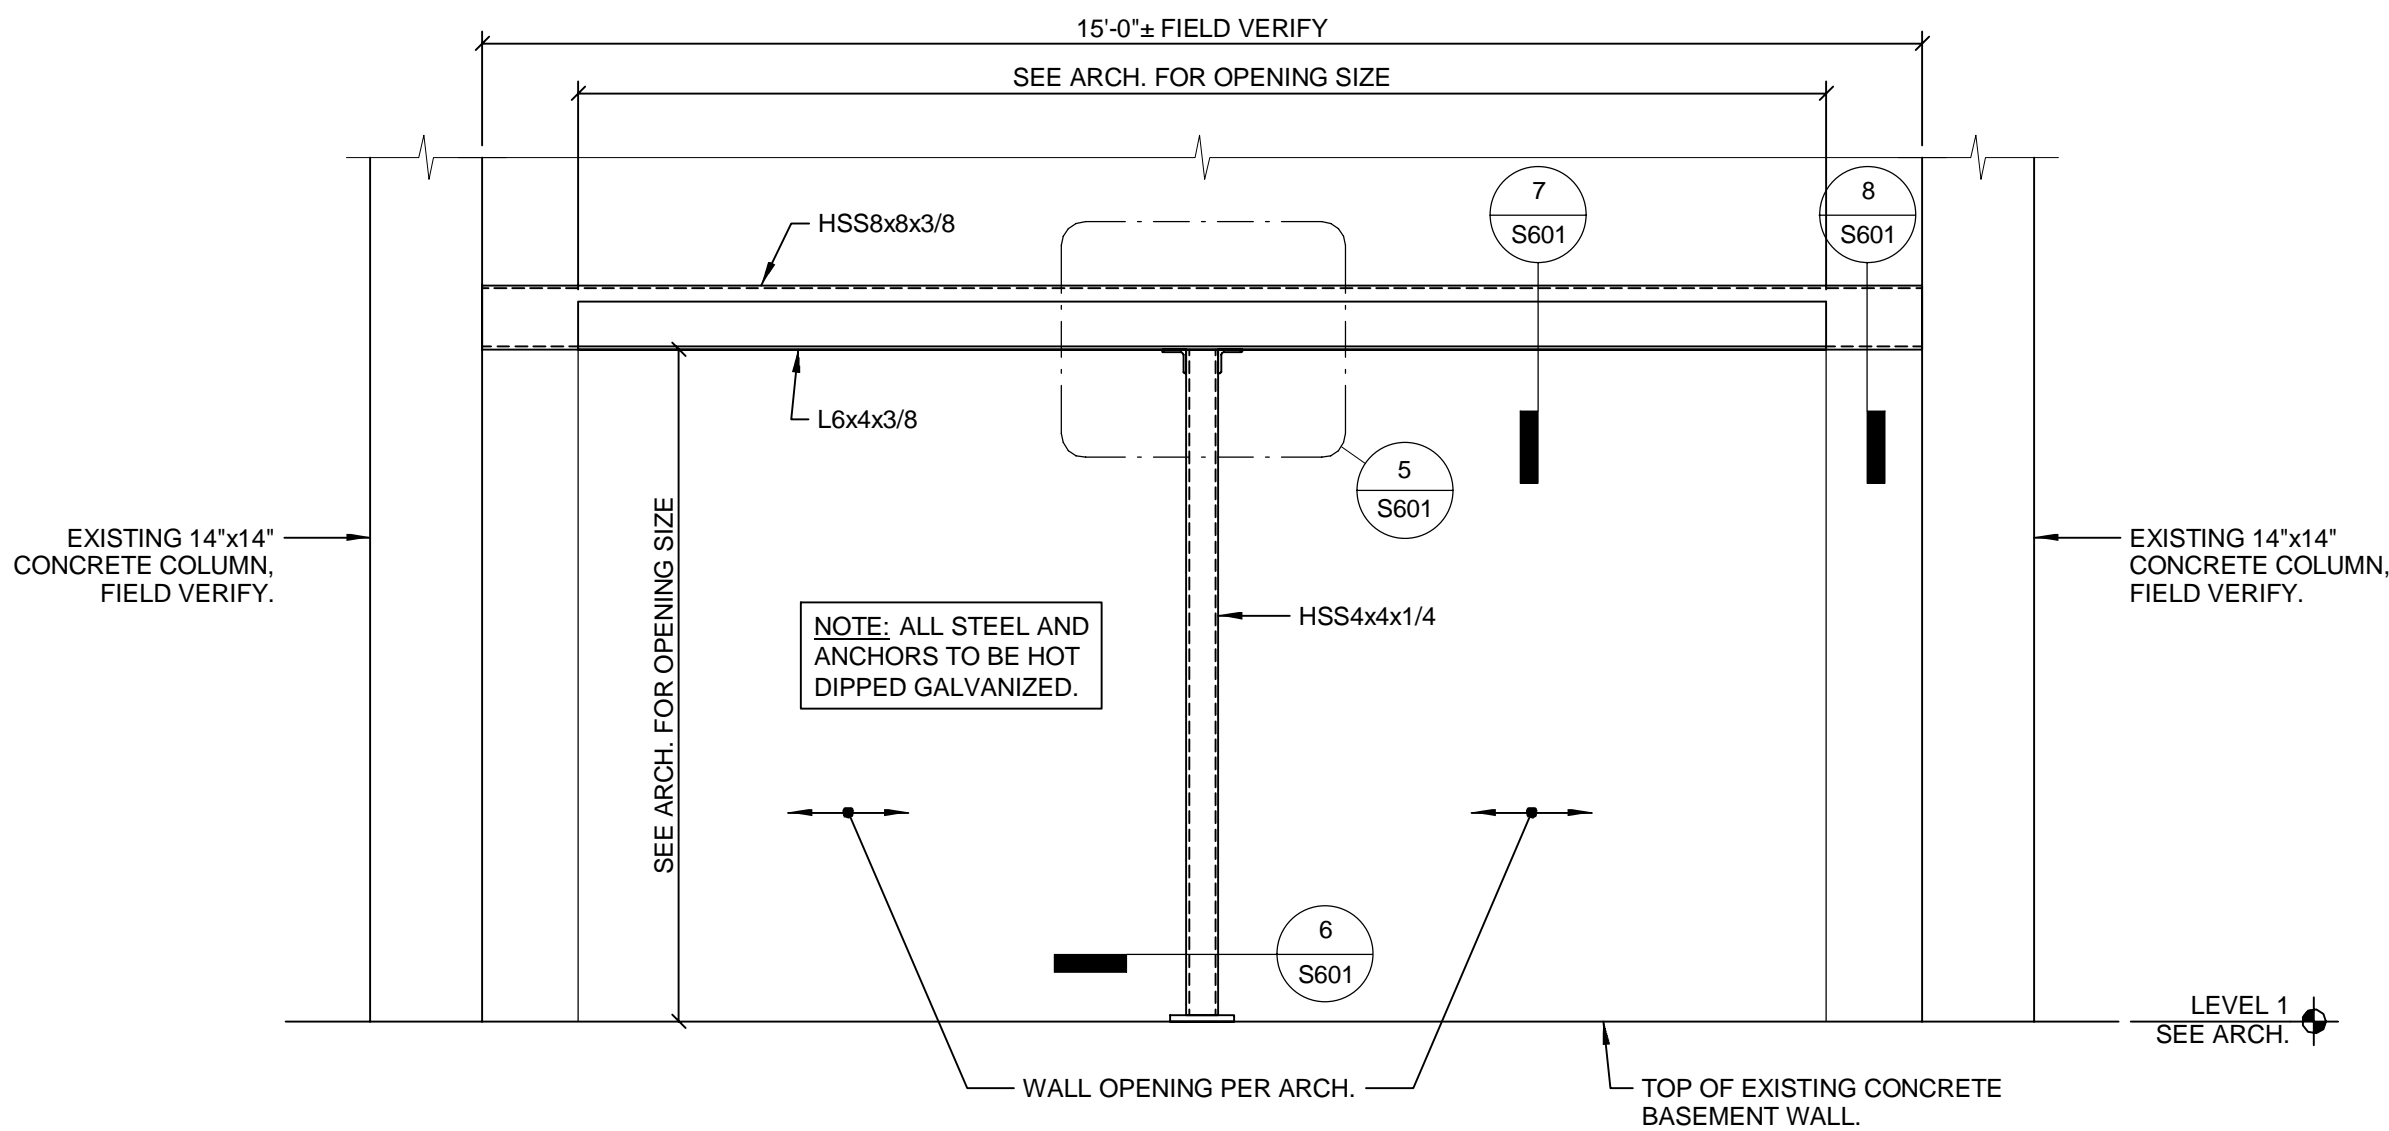


CONSTRUCTION SEQUENCE NOTES FOR WALL OPENING:

1. PROVIDE NEEDLE PLATES THROUGH EXISTING EXTERIOR WALL MORTAR BED JOINTS. SPACE AND SIZE NEEDLE PLATES TO SUPPORT BRICK VENEER AND MASONRY BACK-UP DURING DEMO AND NEW LINTEL INSTALLATION.
2. PROVIDE ADEQUATE SUPPORT OF NEEDLE PLATES ON INTERIOR AND EXTERIOR SIDES OF WALL.
3. ENSURE ADEQUATE SPACE BELOW NEEDLE PLATES FOR WALL REMOVAL AND LINTEL INSTALLATION.
4. REMOVE BRICK AND MASONRY BACK-UP FOR WALL OPENING.
5. INSTALL NEW STEEL POST.
6. INSTALL NEW STEEL LINTEL.
7. REMOVE NEEDLE PLATES AND ASSOCIATED SUPPORTS AFTER LINTEL INSTALLATION IS COMPLETE.
8. PATCH AFFECTED BED JOINTS.


ELEVATION - OPENING IN EXISTING EXTERIOR WALL FOR STOREFRONT WINDOW

1/2" = 1'-0"

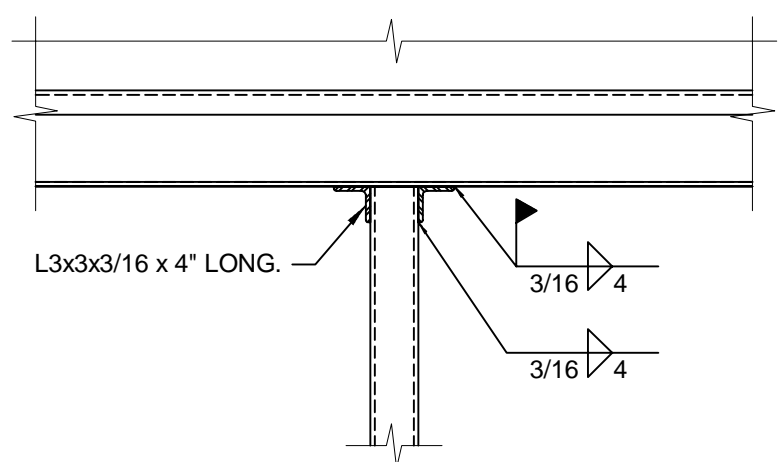


DETAIL

3/4" = 1'-0"

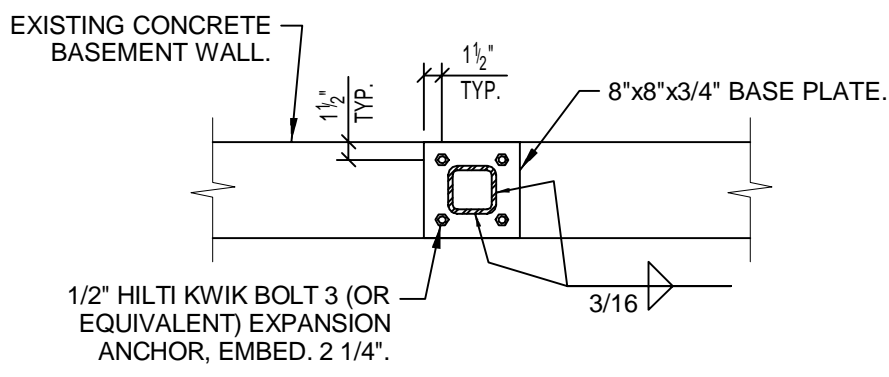


DETAIL

3/4" = 1'-0"

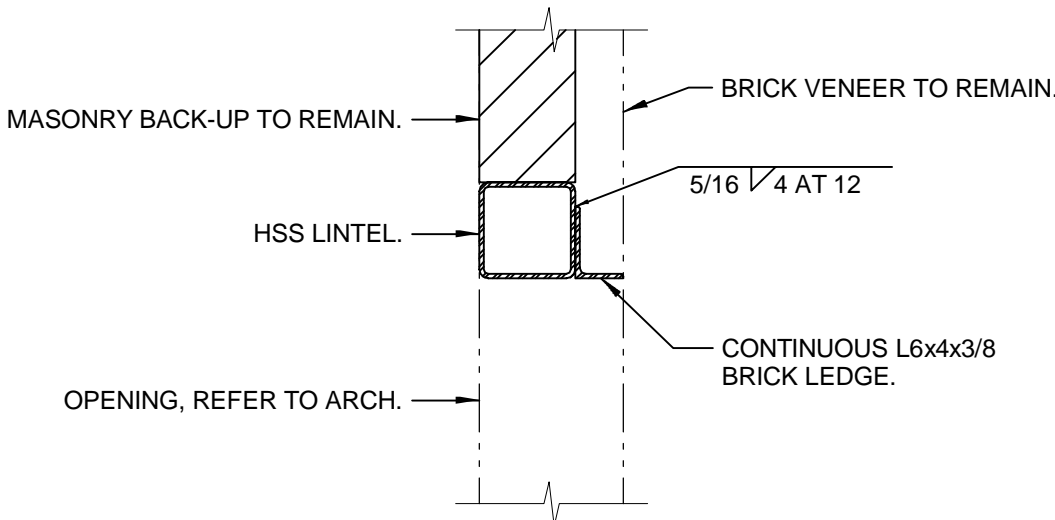


DETAIL

3/4" = 1'-0"

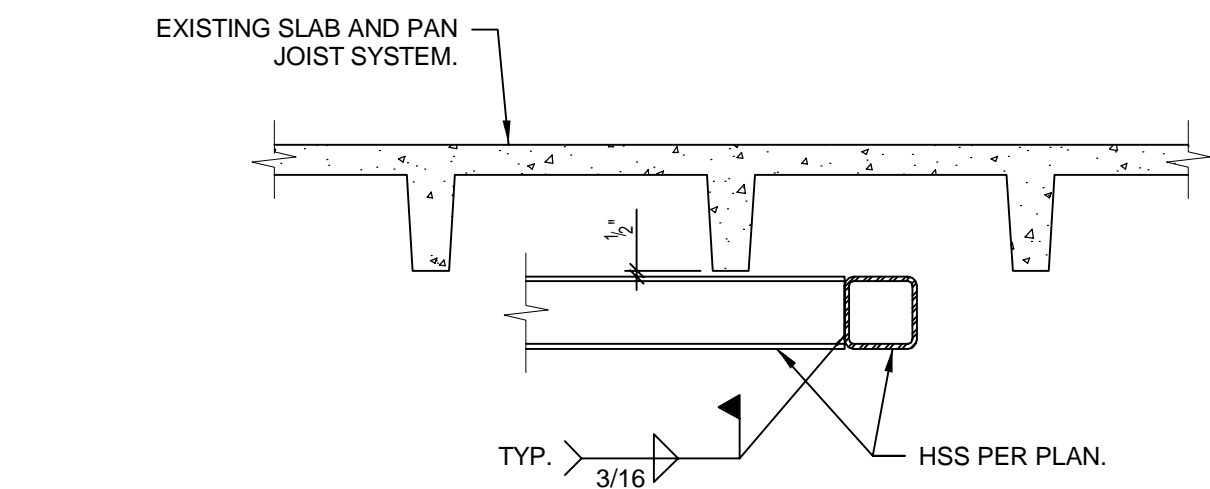


DETAIL

3/4" = 1'-0"

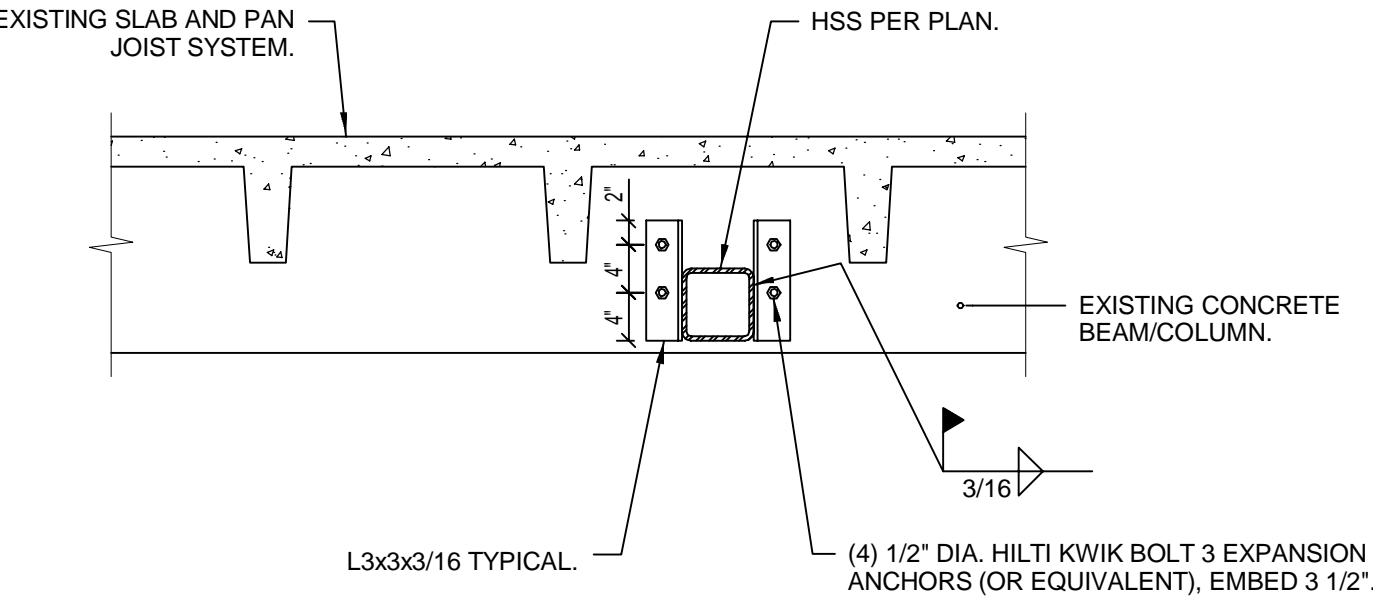


DETAIL

3/4" = 1'-0"

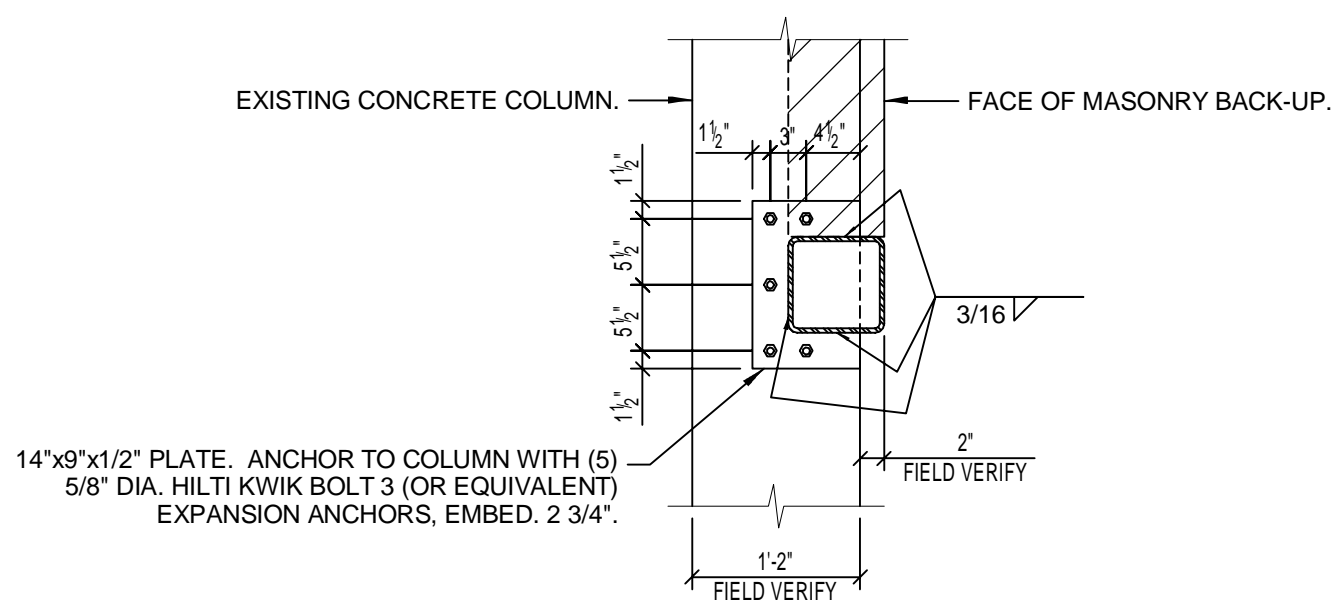


DETAIL

3/4" = 1'-0"

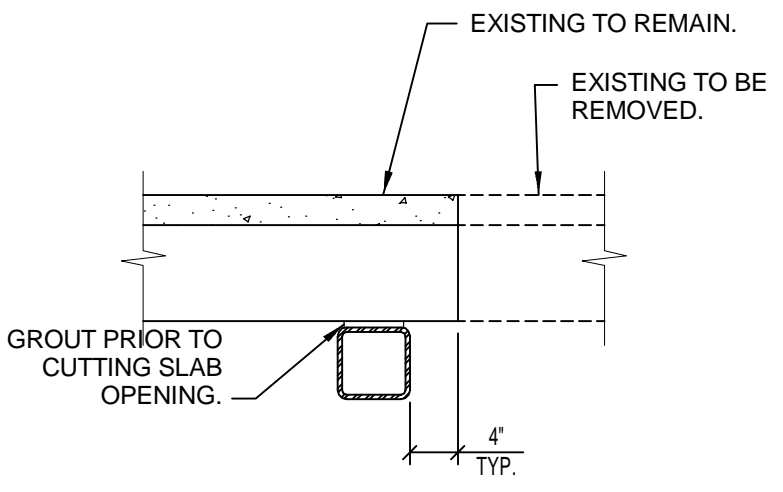


DETAIL

3/4" = 1'-0"

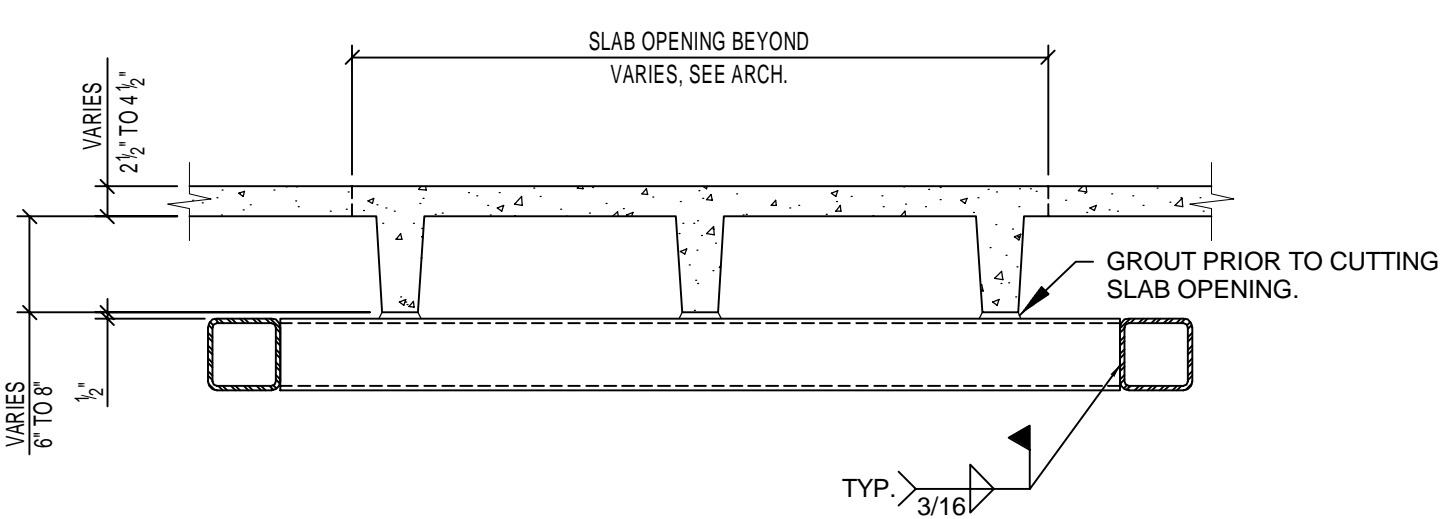


DETAIL

3/4" = 1'-0"

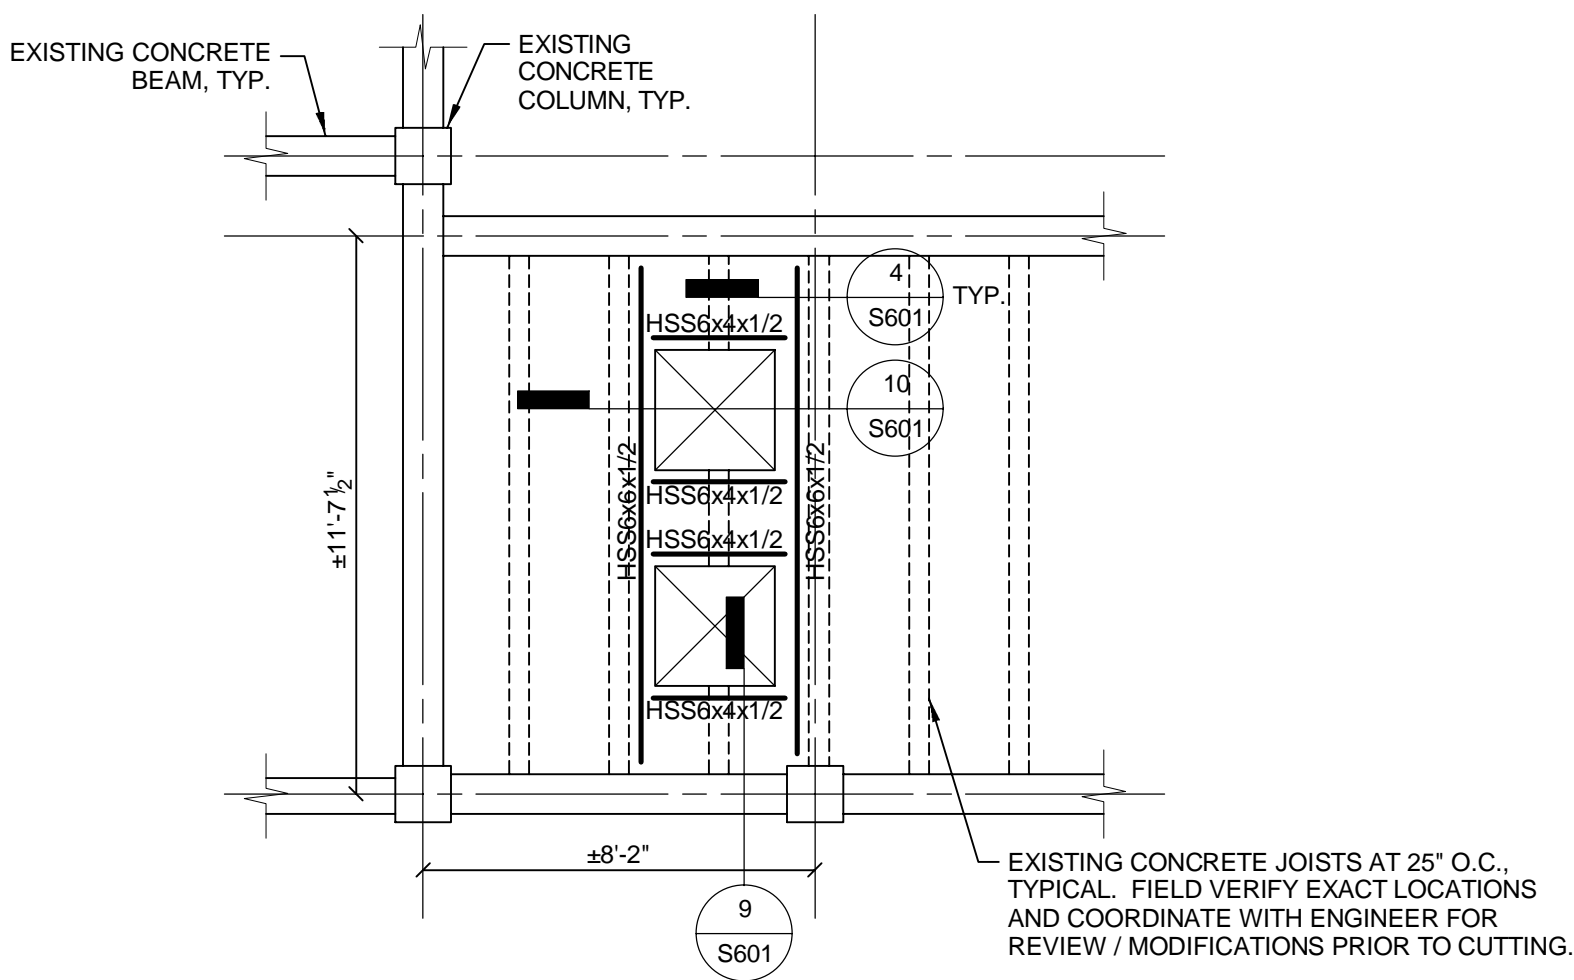

PARTIAL PLAN - CHASE C5 LEVELS 1, 2, AND ATTIC

1/4" = 1'-0"

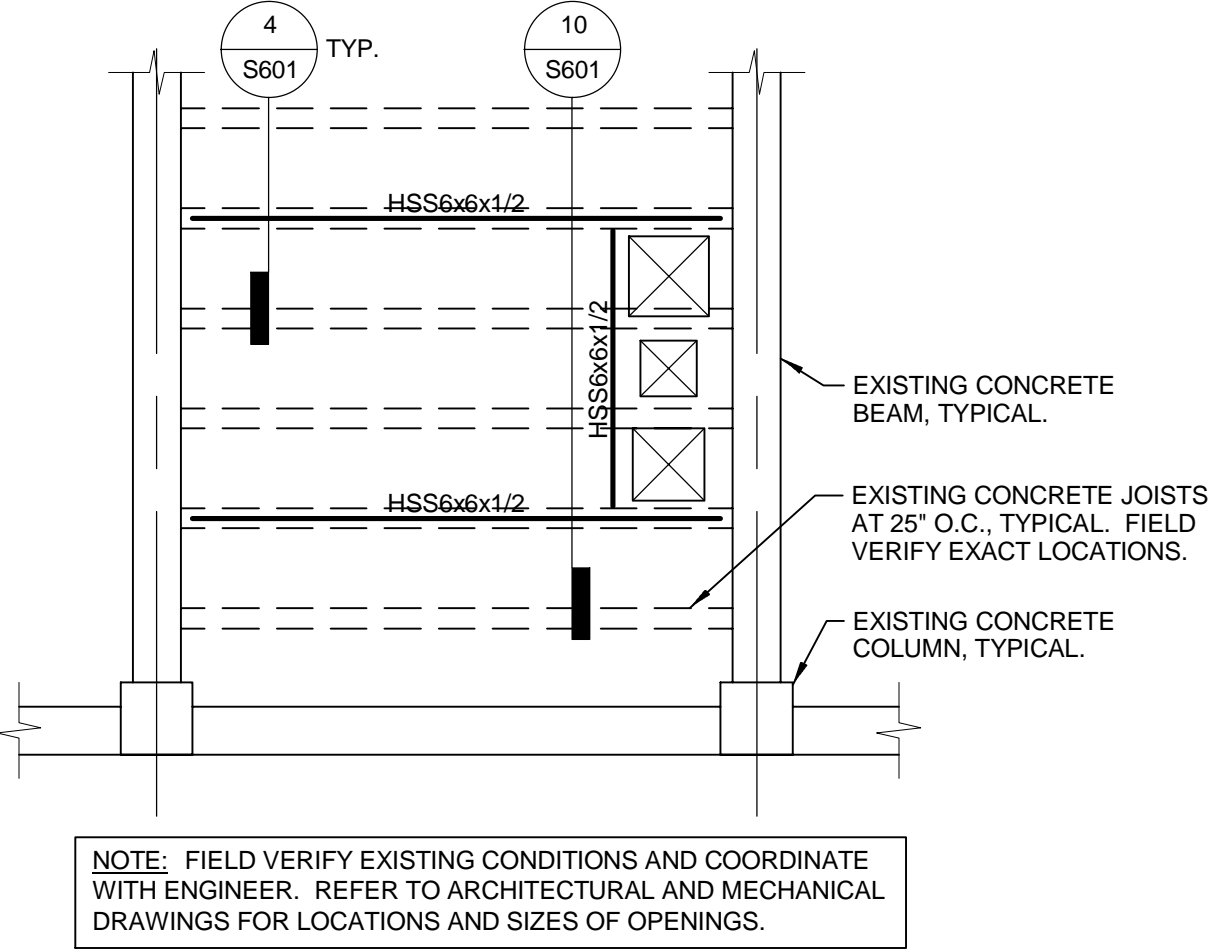

PARTIAL PLAN - CHASE C4 LEVEL 2 AND ATTIC

1/4" = 1'-0"

1	Bid Documents	9/6/13
Revisions		Date

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Drawing Title

EXISTING STRUCTURE MODIFICATIONS - PARTIAL PLANS AND DETAILS

Approved: Project Director

Project Title

Renovate CLC Building 211 West

Location

Chillicothe, Ohio

Date

Sept. 6, 2013

Checked

MCC

Drawn

MRB

Project No.

VA Project No. 538-107
JPA Project No. 11001.00

Building Number

211

Drawing Number

S601

Dwg. 58 of 132

Office of Construction and Facilities Management

Department of Veterans Affairs